


MONASH MENZIES REDEVELOPMENT - STAGE 2

MONASH UNIVERSITY CLAYTON CAMPUS

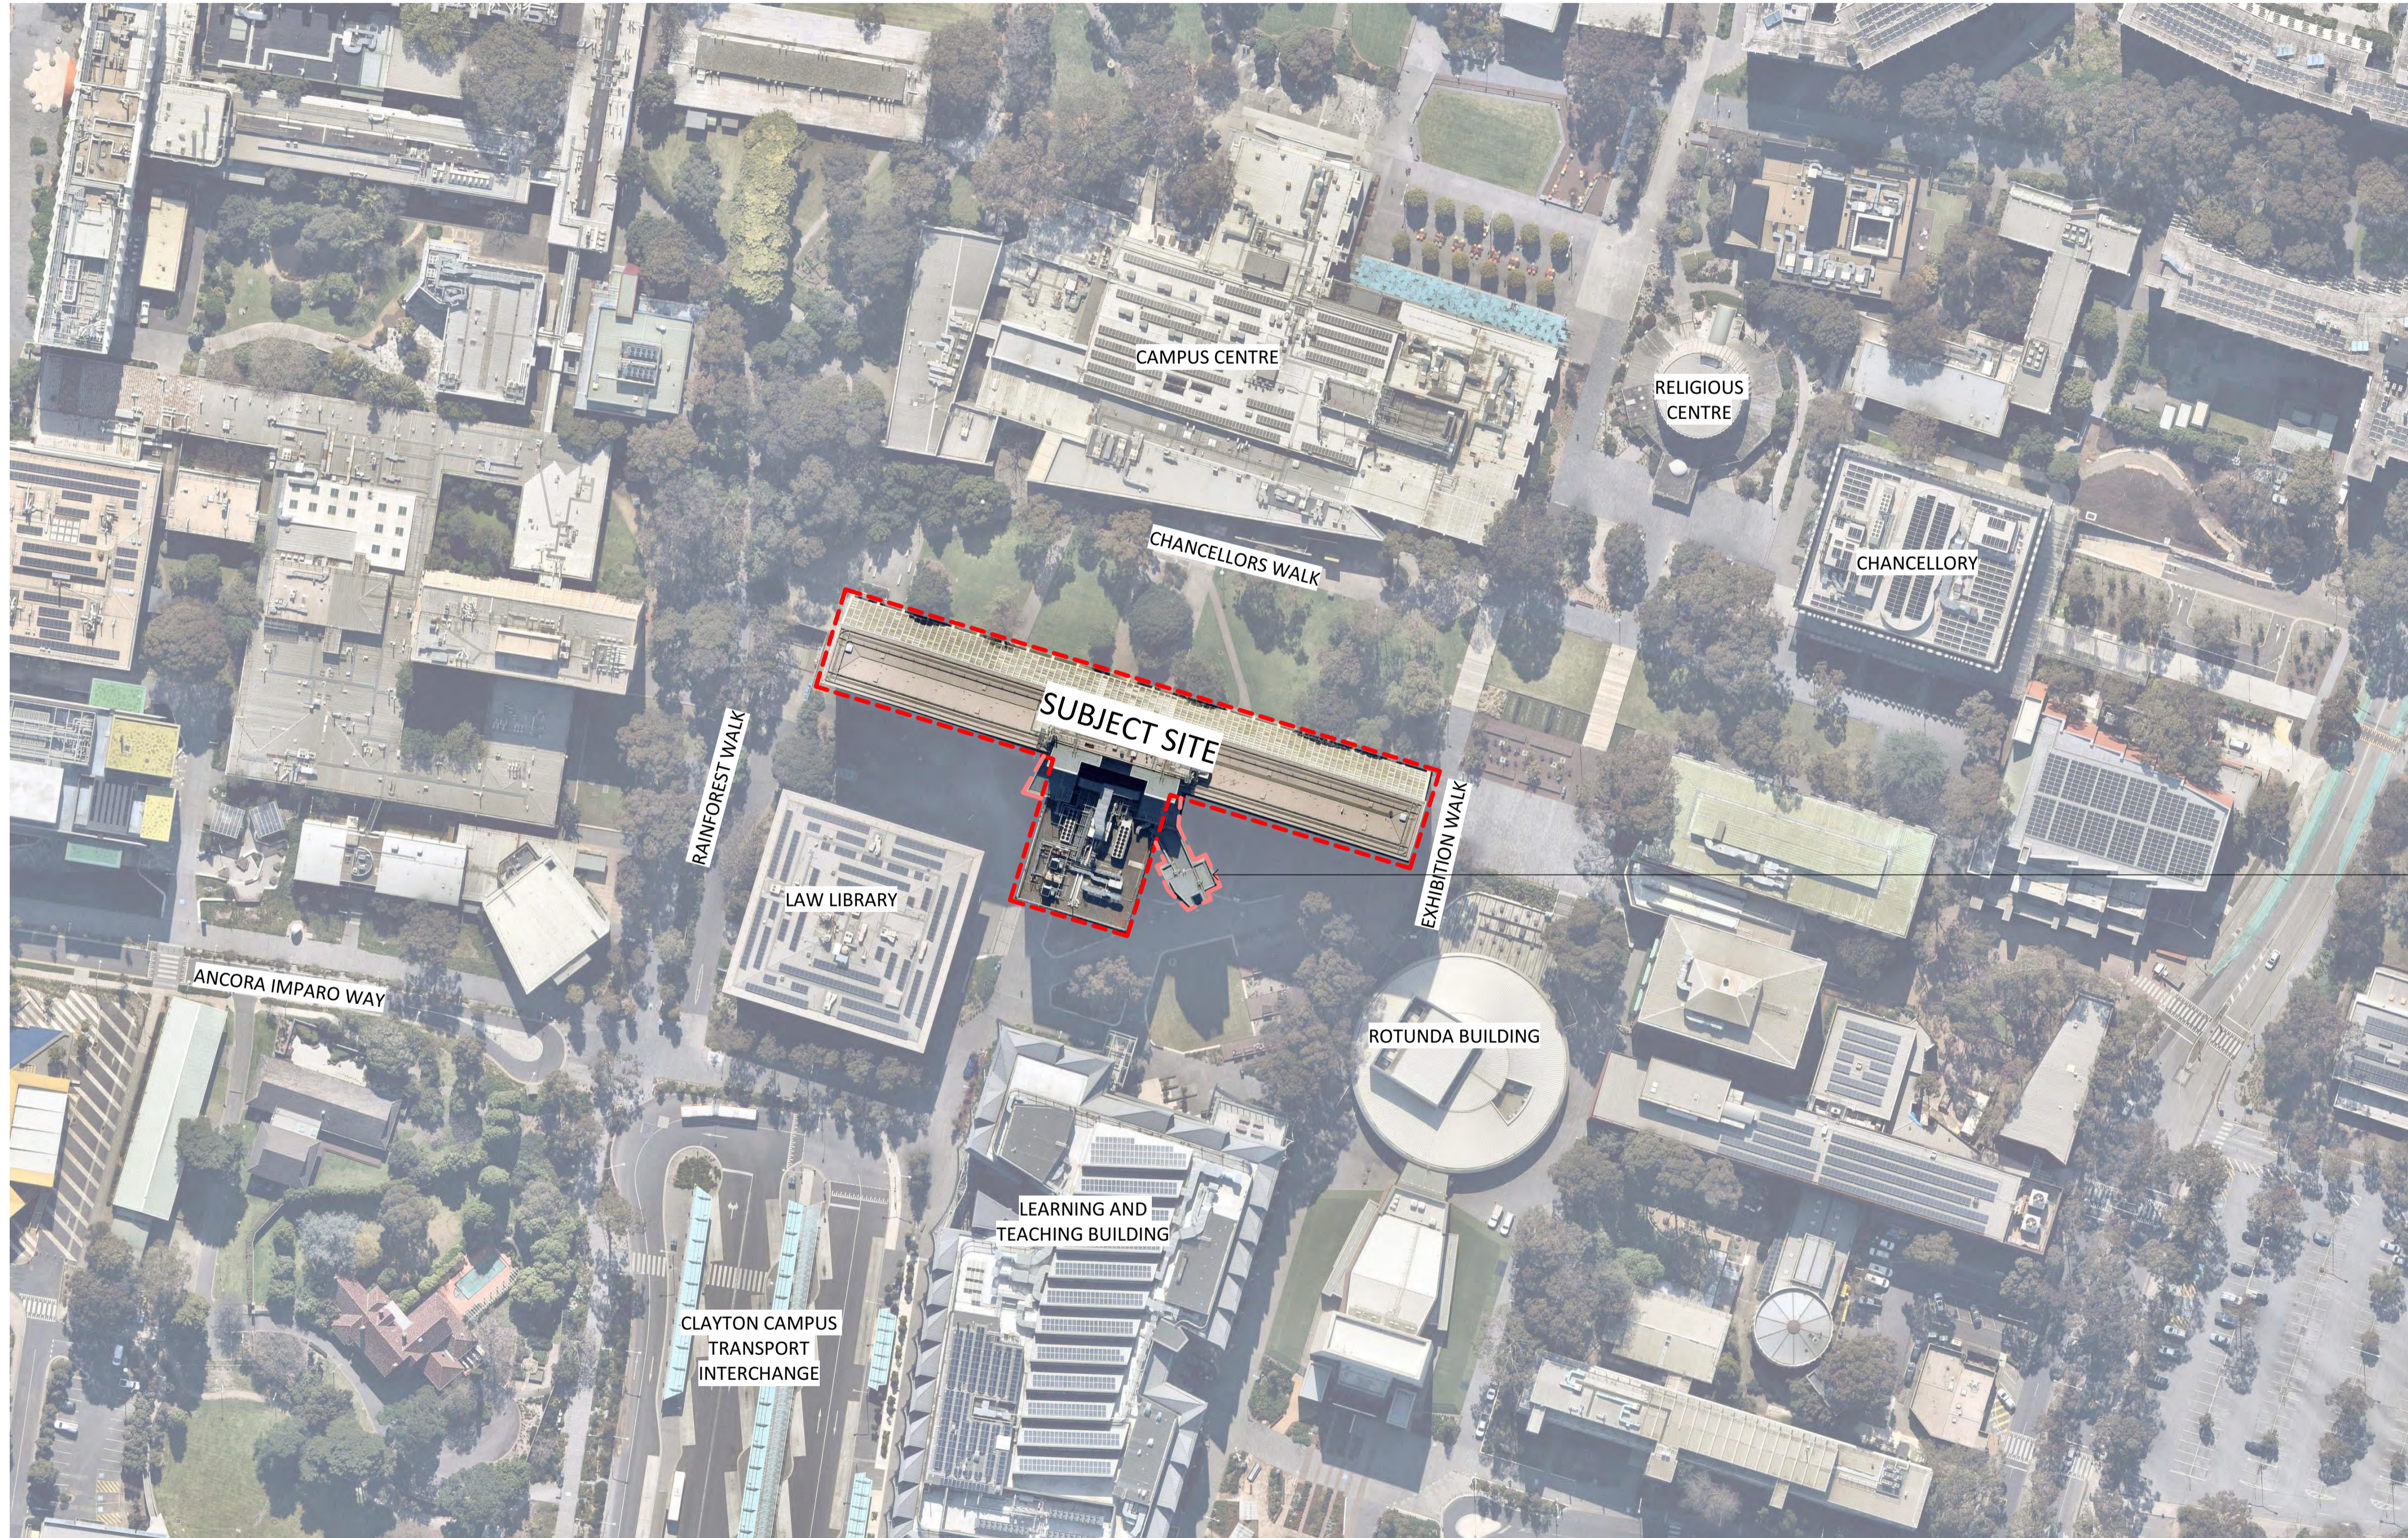

DRAWING REGISTER

A_0010	LOCATION PLAN & DRAWING REGISTER
A_1240	DEMOLITION ROOF PLAN
A_1250	DEMOLITION COLONNADE REFLECTED CEILING PLAN
A_3245	PROPOSED COLONNADE REFLECTED CEILING PLAN
A_3246	PROPOSED ROOF PLAN
A_6001	ELEVATIONS - NORTH - EXISTING
A_6002	ELEVATIONS - SOUTH - EXISTING
A_6003	ELEVATIONS - EAST & WEST - EXISTING
A_6010	ELEVATIONS - NORTH - DEMOLITION
A_6011	ELEVATIONS - SOUTH - DEMOLITION
A_6012	ELEVATIONS - EAST & WEST - DEMOLITION
A_6020	ELEVATIONS - NORTH - PROPOSED
A_6021	ELEVATIONS - SOUTH - PROPOSED
A_6022	ELEVATIONS - EAST & WEST - PROPOSED
A_6023	PART NORTH ELEVATION EAST
A_6024	PART SOUTH ELEVATION EAST
A_6025	PART SOUTH ELEVATION SOUTH
A_6040	TYPICAL WINDOW ELEVATIONS - EXISTING AND PROPOSED
	RENDERS - EXTERNAL
	FINISHES BOARD - EXTERNAL

REFER TO EARLY WORKS DOCUMENTATION

01 LOCATION PLAN
SCALE 1:1000

ACOUSTIC ENGINEERING
Cundall
L2/330 Little Collins Street
Melbourne, VIC 3000
T (03) 9635 3700
cundall.com

BUILDING SURVEYOR
Steve Watson & Partners
Level 8/1350 Queen Street
Melbourne, VIC 3000
T (03) 9380 5558
swpartners.com.au

BUILDING SERVICES ENGINEER + ESD
WSP
Level 15/28 Freshwater Place
Southbank, Vic 3006
T (03) 9861 1111
wsp.com

CIVIL, FACADE & STRUCTURE ENGINEERING
WSP
Level 15/28 Freshwater Place
Southbank, Vic 3006
T (03) 9861 1111
wsp.com

DDA CONSULTANT
Architecture & Access
Level 5 / 369 Royal Parade
Parkville, VIC 3052
T 1300 715 866
architectureandaccess.com.au

REV.	DETAILS	DATE
1	TOWN PLANNING	22/09/21



PROJECT
MONASH MENZIES REDEVELOPMENT - STAGE 2
MONASH UNIVERSITY CLAYTON CAMPUS

DRAWING TITLE
LOCATION PLAN & DRAWING REGISTER


FOR APPROVAL
DESIGN DEVELOPMENT

JOB No. DRAWN CHECKED DATE
MM08 VK MT SEPT 2021

DRAWING No. REVISION
CL_11_A_0010 1

NORTH
SCALE
1:1000@A1

ALL DIMENSIONS ARE IN MILLIMETERS. DO NOT SCALE DRAWINGS FOR CRITICAL DIMENSIONS. CHECK DRAWING IS TO SCALE BY MEASURING SCALE BAR BELOW. VERIFY ALL DIMENSIONS ON SITE BEFORE COMMENCING ANY WORK. SHOP DRAWINGS OR ORDERING MATERIALS.

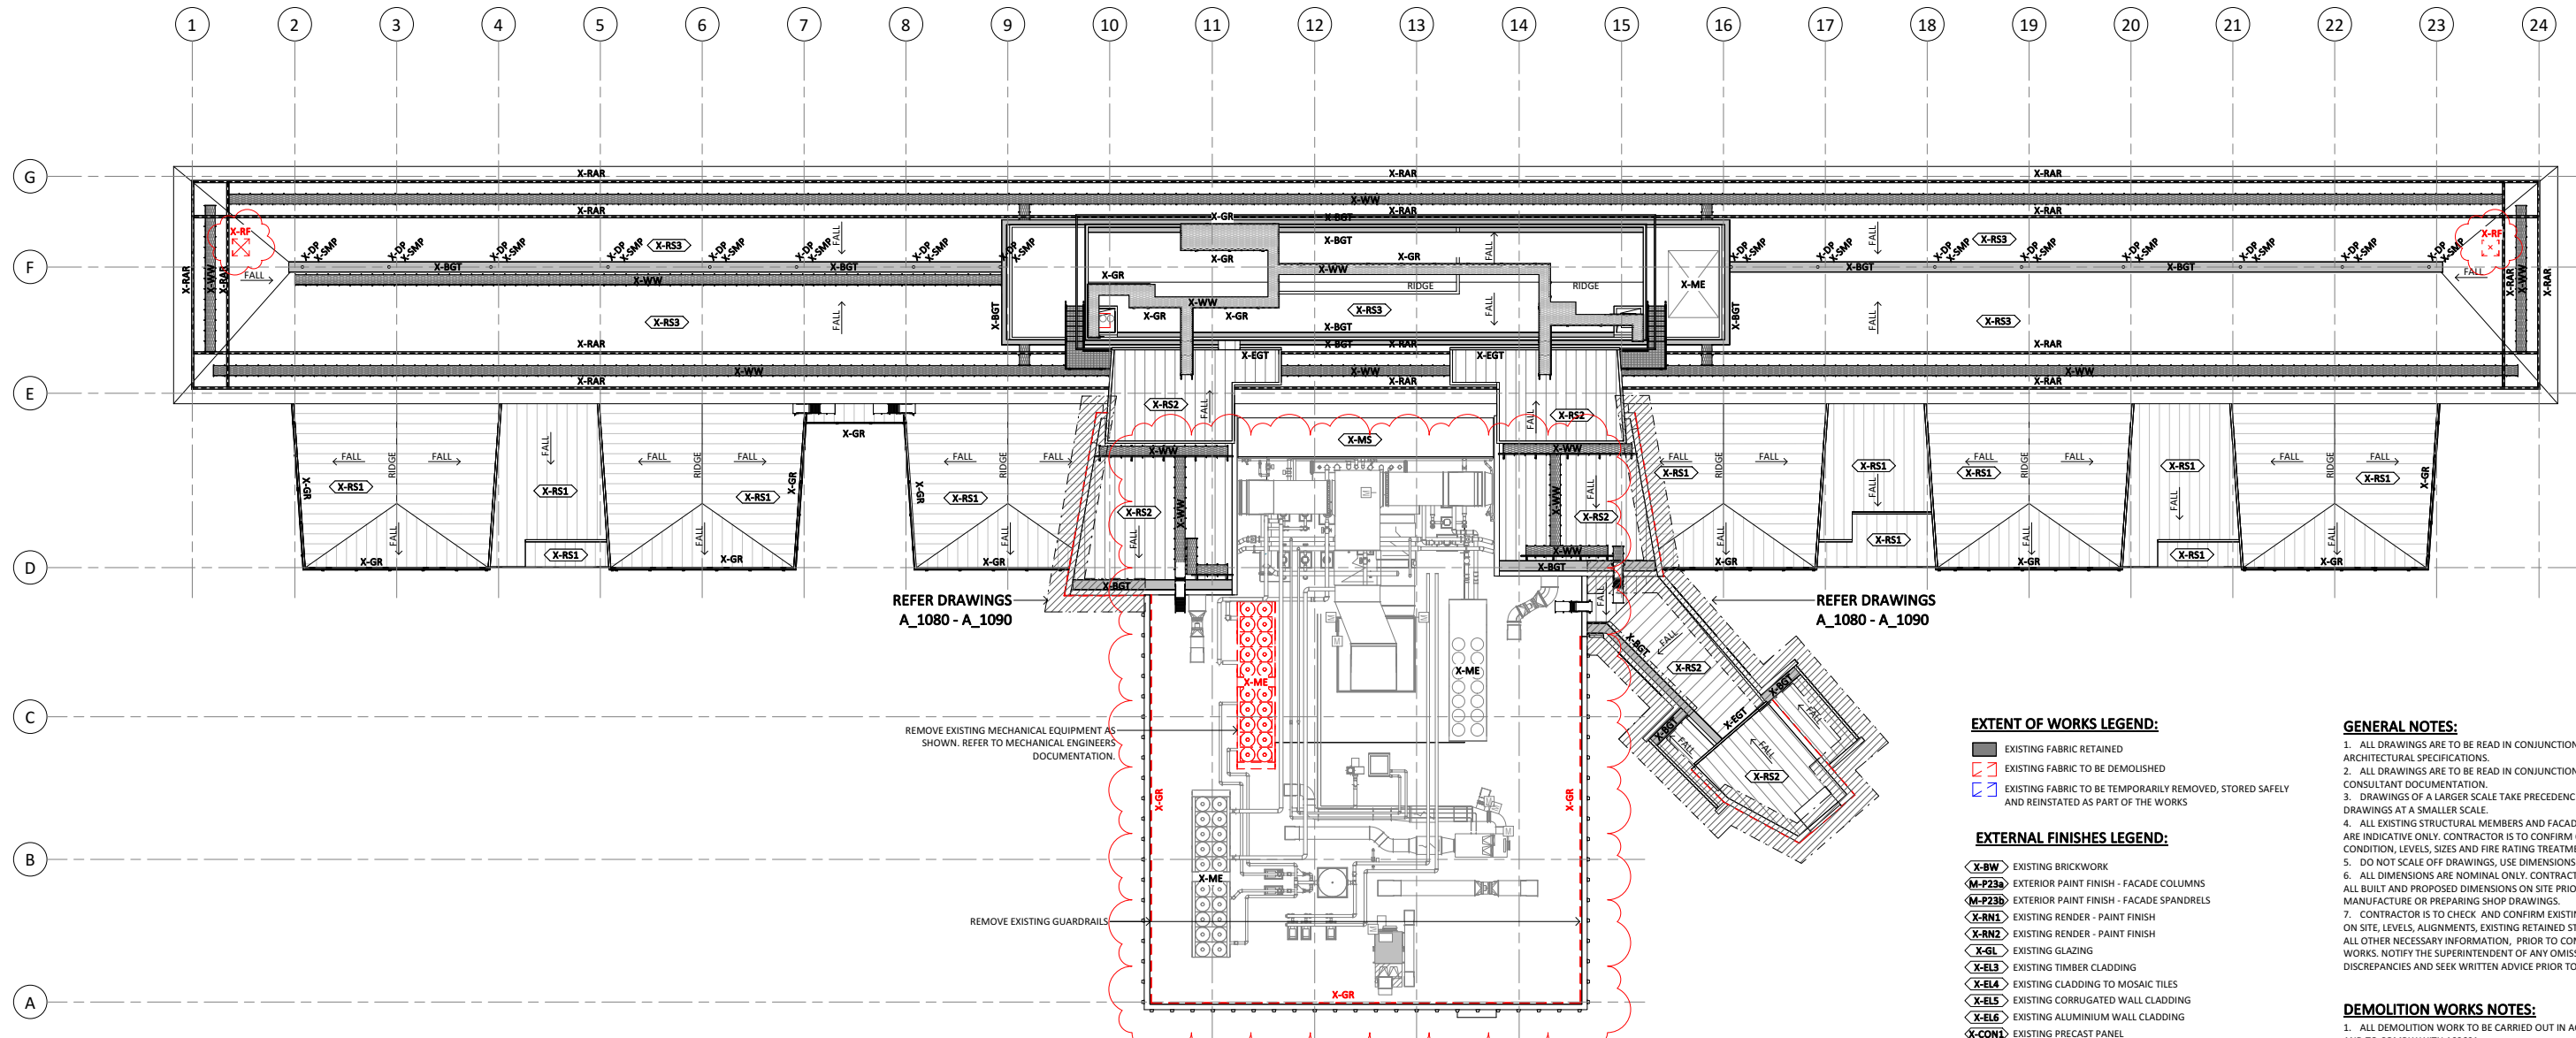

EXTENT OF WORKS LEGEND:

- EXISTING FABRIC RETAINED
- EXISTING FABRIC TO BE DEMOLISHED
- EXISTING FABRIC TO BE TEMPORARILY REMOVED, STORED SAFELY AND REINSTATED AS PART OF THE WORKS

EXTERNAL FINISHES LEGEND:

- X-BW** EXISTING BRICKWORK
- X-P23a** EXTERIOR PAINT FINISH - FACADE COLUMNS
- X-P23b** EXTERIOR PAINT FINISH - FACADE SPANDRELS
- X-RN1** EXISTING RENDER - PAINT FINISH
- X-RN2** EXISTING RENDER - PAINT FINISH
- X-GL** EXISTING GLAZING
- X-EL3** EXISTING TIMBER CLADDING
- X-EL4** EXISTING CLADDING TO MOSAIC TILES
- X-EL5** EXISTING CORRUGATED WALL CLADDING
- X-EL6** EXISTING ALUMINIUM WALL CLADDING
- X-CON1** EXISTING PRECAST PANEL
- X-EL7** EXISTING FIBRE GLASS FASCIA LINING
- X-EL8** EXISTING RIPPLE IRON SOFFIT LINING
- X-AM1** EXISTING METAL CAPPING
- X-SN1** ORIGINAL STONE CLADDING
- X-AM2** EXISTING ALUMINIUM LOUVRE
- X-AM3** EXISTING METAL SCREEN
- X-RS1** EXISTING ROOF SHEETING - TYPE 1
- X-RS2** EXISTING ROOF SHEETING - TYPE 2
- X-RS3** EXISTING ROOF SHEETING - TYPE 3
- X-EL1** EXISTING METAL WALL CLADDING
- X-EL2** EXISTING METAL WALL CLADDING
- X-P24a** EXTERIOR PAINT FINISH - EXISTING METAL WALL CLADDING
- X-CON2** EXTERIOR PAINT FINISH - EXISTING BLOCKWORK WALL
- X-CL1** ORIGINAL TIMBER SLAT CEILING

ROOF LEGEND:

- X-WW** EXISTING WALKWAYS
- X-GR** EXISTING GUARDRAILS
- X-ME** EXISTING MECHANICAL EQUIPMENT
- X-RF** EXISTING ROOF FAN
- X-BGT** EXISTING BOX GUTTER
- X-SMP** EXISTING SUMP
- X-DP** EXISTING DOWNPIPE
- X-EGT** EXISTING EAVES GUTTER
- X-RAR** EXISTING BMU RAIL

GENERAL NOTES:

1. ALL DRAWINGS ARE TO BE READ IN CONJUNCTION WITH THE ARCHITECTURAL SPECIFICATIONS.
2. ALL DRAWINGS ARE TO BE READ IN CONJUNCTION WITH ALL CONSULTANT DOCUMENTATION.
3. DRAWINGS OF A LARGER SCALE TAKE PRECEDENCE OVER DRAWINGS AT A SMALLER SCALE.
4. ALL EXISTING STRUCTURAL MEMBERS AND FACADE CONSTRUCTION ARE INDICATIVE ONLY. CONTRACTOR IS TO CONFIRM ON SITE EXISTING CONDITION, LEVELS, SIZES AND FIRE RATING TREATMENT.
5. DO NOT SCALE OFF DRAWINGS. USE DIMENSIONS ONLY.
6. ALL DIMENSIONS ARE NOMINAL ONLY. CONTRACTOR TO CONFIRM ALL BUILT AND PROPOSED DIMENSIONS ON SITE PRIOR TO MANUFACTURE OR PREPARING SHOP DRAWINGS.
7. CONTRACTOR IS TO CHECK AND CONFIRM EXISTING CONDITIONS ON SITE, LEVELS, ALIGNMENTS, EXISTING RETAINED STRUCTURE AND ALL OTHER NECESSARY INFORMATION, PRIOR TO COMMENCING ANY WORKS. NOTIFY THE SUPERINTENDENT OF ANY OMISSIONS OR DISCREPANCIES AND SEEK WRITTEN ADVICE PRIOR TO PROCEEDING.

DEMOLITION WORKS NOTES:

1. ALL DEMOLITION WORK TO BE CARRIED OUT IN ACCORDANCE WITH AND TO COMPLY WITH AS2601.
2. FOLLOWING DEMOLITION ALL RUBBLE, DEBRIS AND DUST ARE TO BE REMOVED AND DISPOSED OFF SITE IN ACCORDANCE WITH ALL RELEVANT AUTHORITIES REQUIREMENTS AND GUIDELINES.
3. CONTRACTOR IS TO MAKE GOOD ANY DAMAGE CAUSED DUE TO DEMOLITION WORKS. LIAISE WITH SUPERINTENDENT FOR REMEDIATION WORKS.
4. REMOVE EXISTING ALUMINIUM FRAMED WINDOWS AS SHOWN ON THE DRAWINGS. WHERE EXISTING WINDOWS ARE SCORED FOR REMOVAL, REMOVE THE ENTIRE WINDOW AND ALL ASSOCIATED COMPONENTS INCLUDING BUT NOT LIMITED TO FLASHINGS, TAPES, SEALANTS, BRACKETS.
5. RETAIN AND PROTECT ALL FACADE ELEMENTS IN POSITION, INCLUDING BUT NOT LIMITED TO CONCRETE SPANDRELS, MULLIONS, BEAMS, SOFFIT LINING AND RENDERED FINISH.
6. REMOVE ALL EXISTING EXTERNAL ROLLER BLINDS INCLUDING ASSOCIATED HEAD BOX, FLASHINGS AND BRACKETS.
7. REMOVE ALL MECHANICAL LOUVERS AND ADJACENT TRIMS AND FIXINGS.
8. REMOVE ALL REDUNDANT SERVICES.
9. ALLOW TO REMOVE ALL ASBESTOS AND DAMAGED SEALANTS.

PROTECTION NOTES:

1. CONTRACTOR TO PREPARE DILAPIDATION REPORT OF EXISTING CONDITIONS FOR SUPERINTENDENT'S APPROVAL PRIOR TO COMMENCEMENT OF WORKS.
2. PROTECT EXISTING FABRIC TO BE RETAINED FROM DAMAGE DURING DEMOLITION WORKS INCLUDING, BUT NOT LIMITED TO DOORS, GLAZED CURTAIN WALLS AND WINDOWS, WALLS, FLOORS, CEILINGS, STAIRS, ROOFING, SAFE ROOF ACCESS SYSTEM, CLADDING SYSTEMS, SERVICES, FITTINGS AND FIXTURES, FRAMING OR STRUCTURAL ELEMENTS.
3. CONTRACTOR TO CONFIRM, RETAIN AND PROTECT ALL EXISTING FIRE RATED TREATMENTS, INCLUDING SPRINKLER SYSTEM, INTERNAL AND EXTERNAL LININGS, CLADDINGS AND FIRE RATED COATINGS TO STRUCTURAL ELEMENTS, UNLESS NOTED OTHERWISE.
4. WHERE INTERNAL OR EXTERNAL ELEMENTS ARE REQUIRED TO BE REMOVED TO ENABLE THE WORKS, THESE ARE TO BE STORED AND REINSTATED TO MATCH THE EXISTING CONDITION.
5. CONTRACTOR TO REPAIR ANY DAMAGE TO RETAINED FABRIC TO MATCH EXISTING CONDITION, TO THE SUPERINTENDENT'S APPROVAL.
6. MAINTAIN THE EXISTING BUILDING IN A SECURE AND WATER TIGHT CONDITION AT ALL TIMES THROUGHOUT THE WORKS
7. PROTECT THE SITE AT ALL TIMES FROM UNAUTHORISED ACCESS
8. PROTECT ALL LANDSCAPE LOCATED IN SITE COMPOUND

REFER DRAWINGS A_1080 - A_1090

REFER DRAWINGS A_1080 - A_1090

REMOVE EXISTING MECHANICAL EQUIPMENT AS SHOWN. REFER TO MECHANICAL ENGINEERS DOCUMENTATION.

REMOVE EXISTING GUARDRAILS

ACOUSTIC ENGINEERING
Cundall
 L2/330 Little Collins Street
 Melbourne, VIC 3000
 T (03) 9635 3700
 cundall.com

BUILDING SURVEYOR
Steve Watson & Partners
 Level 6/ 350 Queen Street
 Melbourne, VIC 3000
 T (03) 9380 5558
 swpartners.com.au

BUILDING SERVICES ENGINEER + ESD
WSP
 Level 15/28 Freshwater Place
 Southbank, Vic 3006
 T (03) 9661 1111
 wsp.com

CIVIL, FACADE & STRUCTURE ENGINEERING
WSP
 Level 15/28 Freshwater Place
 Southbank, Vic 3006
 T (03) 9661 1111
 wsp.com

DDA CONSULTANT
Architecture & Access
 Level 5/ 369 Royal Parade
 Parkville, VIC 3052
 T 1300 715 866
 architectureandaccess.com.au

REV.	DETAILS	DATE
2	TOWN PLANNING	25/11/2021
1	TOWN PLANNING	22/09/2021



PROJECT
MONASH MENZIES REDEVELOPMENT - STAGE 2
 MONASH UNIVERSITY CLAYTON CAMPUS

DRAWING TITLE
DEMOLITION ROOF PLAN


FOR APPROVAL
 TOWN PLANNING

SCALE
 1:200@A1

JOB No. DRAWN CHECKED DATE
 MM08 VK MT SEPT 2021

DRAWING No. REVISION
 CL_11_A_1240 2

ALL DIMENSIONS ARE IN MILLIMETERS. DO NOT SCALE DRAWINGS FOR CRITICAL DIMENSIONS. CHECK DRAWING IS TO SCALE BY MEASURING SCALE BAR BELOW. VERIFY ALL DIMENSIONS ON SITE BEFORE COMMENCING ANY WORK. SHOP DRAWINGS OR ORDERING MATERIALS.

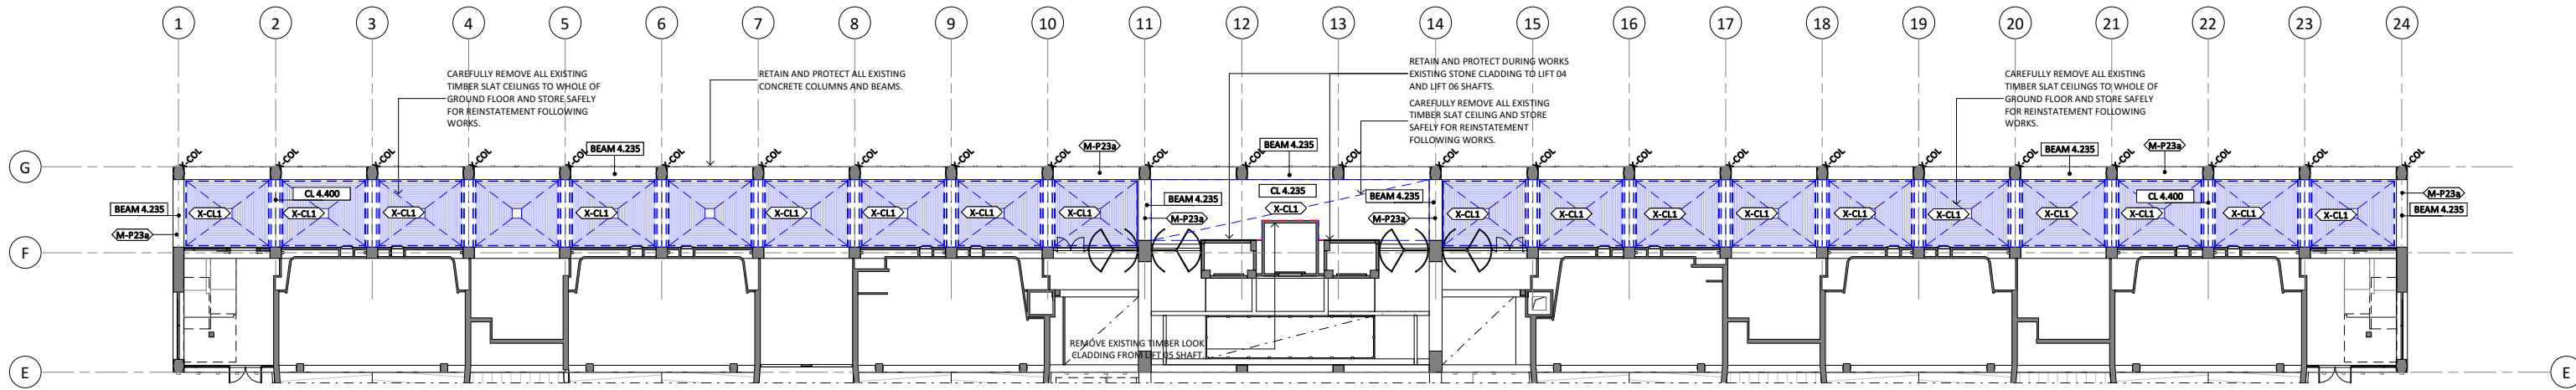

01 GROUND FLOOR COLONNADE RCP - DEMOLITION
SCALE 1 : 200

EXTENT OF WORKS LEGEND:

- EXISTING FABRIC RETAINED
- EXISTING FABRIC TO BE DEMOLISHED
- EXISTING FABRIC TO BE TEMPORARILY REMOVED, STORED SAFELY AND REINSTATEMENT AS PART OF THE WORKS

EXTERNAL FINISHES LEGEND:

- EXISTING BRICKWORK
- EXTERIOR PAINT FINISH - FACADE COLUMNS
- EXTERIOR PAINT FINISH - FACADE SPANDRELS
- EXISTING RENDER - PAINT FINISH
- EXISTING RENDER - PAINT FINISH
- EXISTING GLAZING
- EXISTING TIMBER CLADDING
- EXISTING CLADDING TO MOSAIC TILES
- EXISTING CORRUGATED WALL CLADDING
- EXISTING ALUMINIUM WALL CLADDING
- EXISTING PRECAST PANEL
- EXISTING FIBRE GLASS FASCIA LINING
- EXISTING RIPPLE IRON SOFFIT LINING
- EXISTING METAL CAPPING
- ORIGINAL STONE CLADDING
- EXISTING ALUMINIUM LOUVRE
- EXISTING METAL SCREEN
- EXISTING ROOF SHEETING - TYPE 1
- EXISTING ROOF SHEETING - TYPE 2
- EXISTING ROOF SHEETING - TYPE 3
- EXISTING METAL WALL CLADDING
- EXISTING METAL WALL CLADDING
- EXTERIOR PAINT FINISH - EXISTING METAL WALL CLADDING
- EXTERIOR PAINT FINISH - EXISTING BLOCKWORK WALL
- ORIGINAL TIMBER SLAT CEILING

GENERAL NOTES:

1. ALL DRAWINGS ARE TO BE READ IN CONJUNCTION WITH THE ARCHITECTURAL SPECIFICATIONS.
2. ALL DRAWINGS ARE TO BE READ IN CONJUNCTION WITH ALL CONSULTANT DOCUMENTATION.
3. DRAWINGS OF A LARGER SCALE TAKE PRECEDENCE OVER DRAWINGS AT A SMALLER SCALE.
4. ALL EXISTING STRUCTURAL MEMBERS AND FACADE CONSTRUCTION ARE INDICATIVE ONLY. CONTRACTOR IS TO CONFIRM ON SITE EXISTING CONDITION, LEVELS, SIZES AND FIRE RATING TREATMENT.
5. DO NOT SCALE OFF DRAWINGS, USE DIMENSIONS ONLY.
6. ALL DIMENSIONS ARE NOMINAL ONLY. CONTRACTOR TO CONFIRM ALL BUILT AND PROPOSED DIMENSIONS ON SITE PRIOR TO MANUFACTURE OR PREPARING SHOP DRAWINGS.
7. CONTRACTOR IS TO CHECK AND CONFIRM EXISTING CONDITIONS ON SITE, LEVELS, ALIGNMENTS, EXISTING RETAINED STRUCTURE AND ALL OTHER NECESSARY INFORMATION, PRIOR TO COMMENCING ANY WORKS. NOTIFY THE SUPERINTENDENT OF ANY OMISSIONS OR DISCREPANCIES AND SEEK WRITTEN ADVICE PRIOR TO PROCEEDING.

DEMOLITION WORKS NOTES:

1. ALL DEMOLITION WORK TO BE CARRIED OUT IN ACCORDANCE WITH AND TO COMPLY WITH AS2601.
2. FOLLOWING DEMOLITION ALL RUBBLE, DEBRIS AND DUST ARE TO BE REMOVED AND DISPOSED OFF SITE IN ACCORDANCE WITH ALL RELEVANT AUTHORITIES REQUIREMENTS AND GUIDELINES.
3. CONTRACTOR IS TO MAKE GOOD ANY DAMAGE CAUSED DUE TO DEMOLITION WORKS. LIAISE WITH SUPERINTENDENT FOR REMEDIATION WORKS.
4. REMOVE EXISTING ALUMINIUM FRAMED WINDOWS AS SHOWN ON THE DRAWINGS. WHERE EXISTING WINDOWS ARE SCOPED FOR REMOVAL, REMOVE THE ENTIRE WINDOW AND ALL ASSOCIATED COMPONENTS INCLUDING BUT NOT LIMITED TO FLASHINGS, TAPES, SEALANTS, BRACKETS.
5. RETAIN AND PROTECT ALL FACADE ELEMENTS IN POSITION, INCLUDING BUT NOT LIMITED TO CONCRETE SPANDRELS, MULLIONS, BEAMS, SOFFIT LINING AND RENDERED FINISH.
6. REMOVE ALL EXISTING EXTERNAL ROLLER BLINDS INCLUDING ASSOCIATED HEAD BOX, FLASHINGS AND BRACKETS.
7. REMOVE ALL MECHANICAL LOUVERS AND ADJACENT TRIMS AND FIXINGS.
8. REMOVE ALL REDUNDANT SERVICES.
9. ALLOW TO REMOVE ALL ASBESTOS AND DAMAGED SEALANTS.

PROTECTION NOTES:

1. CONTRACTOR TO PREPARE DILAPIDATION REPORT OF EXISTING CONDITIONS FOR SUPERINTENDENT'S APPROVAL PRIOR TO COMMENCEMENT OF WORKS.
2. PROTECT EXISTING FABRIC TO BE RETAINED FROM DAMAGE DURING DEMOLITION WORKS INCLUDING, BUT NOT LIMITED TO DOORS, GLAZED CURTAIN WALLS AND WINDOWS, WALLS, FLOORS, CEILINGS, STAIRS, ROOFING, SAFE ROOF ACCESS SYSTEM, CLADDING SYSTEMS, SERVICES, FITTINGS AND FIXTURES, FRAMING OR STRUCTURAL ELEMENTS.
3. CONTRACTOR TO CONFIRM, RETAIN AND PROTECT ALL EXISTING FIRE RATED TREATMENTS, INCLUDING SPRINKLER SYSTEM, INTERNAL AND EXTERNAL LININGS, CLADDINGS AND FIRE RATED COATINGS TO STRUCTURAL ELEMENTS, UNLESS NOTED OTHERWISE.
4. WHERE INTERNAL OR EXTERNAL ELEMENTS ARE REQUIRED TO BE REMOVED TO ENABLE THE WORKS, THESE ARE TO BE STORED AND REINSTATEMENT TO MATCH THE EXISTING CONDITION.
5. CONTRACTOR TO REPAIR ANY DAMAGE TO RETAINED FABRIC TO MATCH EXISTING CONDITION, TO THE SUPERINTENDENT'S APPROVAL.
6. MAINTAIN THE EXISTING BUILDING IN A SECURE AND WATER TIGHT CONDITION AT ALL TIMES THROUGHOUT THE WORKS
7. PROTECT THE SITE AT ALL TIMES FROM UNAUTHORISED ACCESS
8. PROTECT ALL LANDSCAPE LOCATED IN SITE COMPOUND

CEILING LEGEND:

- EXISTING CONCRETE COLUMN

ACOUSTIC ENGINEERING
Cundall
L2/330 Little Collins Street
Melbourne, VIC 3000
T (03) 9635 3700
cundall.com

BUILDING SURVEYOR
Steve Watson & Partners
Level 6/ 330 Queen Street
Melbourne, VIC 3000
T (03) 9380 5558
swpartners.com.au

BUILDING SERVICES ENGINEER + ESD
WSP
Level 15/28 Freshwater Place
Southbank, Vic 3006
T (03) 9861 1111
wsp.com

CIVIL, FACADE & STRUCTURE ENGINEERING
WSP
Level 15/28 Freshwater Place
Southbank, Vic 3006
T (03) 9861 1111
wsp.com

DDA CONSULTANT
Architecture & Access
Level 5 / 369 Royal Parade
Parkville, VIC 3052
T 1300 715 866
architectureandaccess.com.au

REV.	DETAILS	DATE
3	TOWN PLANNING	25/11/2021
2	TOWN PLANNING	22/09/2021
1	SCHEMATIC DESIGN	30/08/2021



PROJECT
MONASH MENZIES REDEVELOPMENT - STAGE 2
MONASH UNIVERSITY CLAYTON CAMPUS

DRAWING TITLE
DEMOLITION COLONNADE REFLECTED CEILING PLAN

FOR APPROVAL
TOWN PLANNING


JOB No. DRAWN CHECKED DATE
MM08 VK MT SEPT 2021

DRAWING No. REVISION
CL_11_00_A_1250 3



SCALE
1:200@A1

ALL DIMENSIONS ARE IN MILLIMETERS. DO NOT SCALE DRAWINGS FOR CRITICAL DIMENSIONS. CHECK DRAWING IS TO SCALE BY MEASURING SCALE BAR BELOW. VERIFY ALL DIMENSIONS ON SITE BEFORE COMMENCING ANY WORK. SHOP DRAWINGS OR ORDERING MATERIALS.

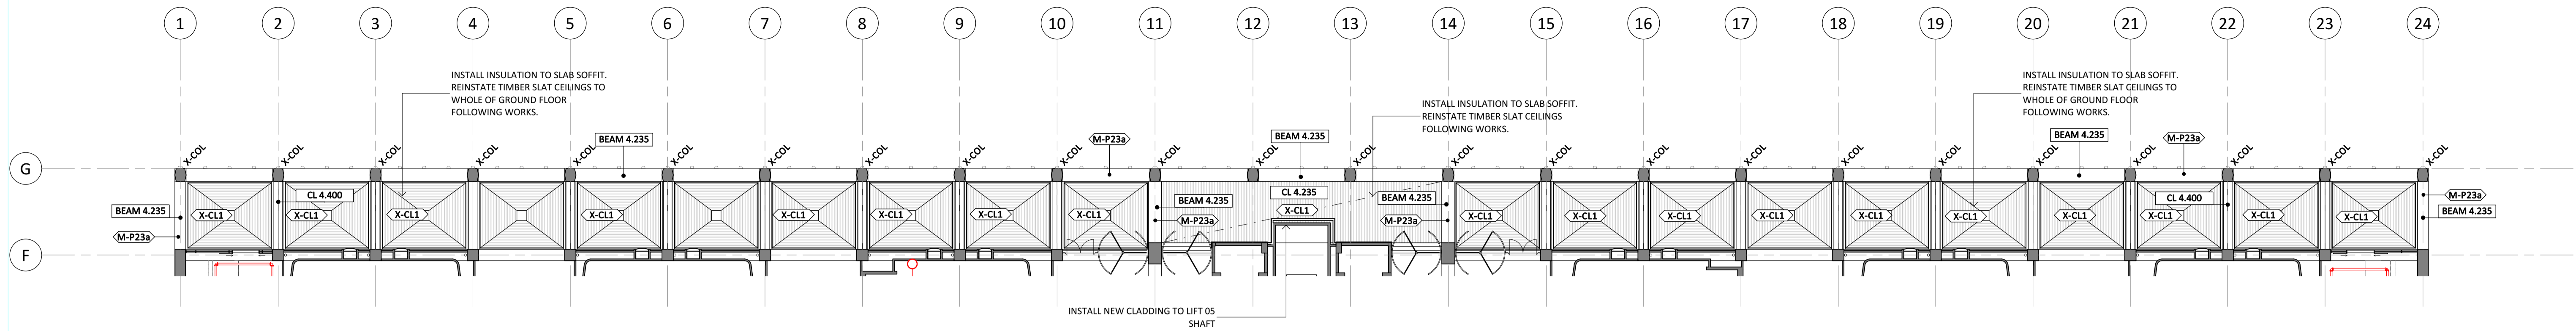

02 GROUND FLOOR COLONNADE RCP - PROPOSED
SCALE 1 : 200

EXTERNAL FINISHES LEGEND:

- <X-BW> EXISTING BRICKWORK
- <M-P23a> EXTERIOR PAINT FINISH - FACADE COLUMNS
- <M-P23b> EXTERIOR PAINT FINISH - FACADE SPANDRELS
- <X-RN1> EXISTING RENDER - PAINT FINISH
- <X-RN2> EXISTING RENDER - PAINT FINISH
- <X-GL> EXISTING GLAZING
- <GL-9> HIGH PERFORMANCE EXTERNAL GLAZING - NORTH FACADE
- <GL-10> HIGH PERFORMANCE EXTERNAL GLAZING - OTHER FACADES
- <EL-01> NEW ALUMINIUM CLADDING - KNUCKLE
- <EL-02> NEW REINFORCED PRESSED CEMENT PANEL - NORTH FACADE
- <X-EL4> EXISTING CLADDING TO MOSAIC TILES
- <X-EL5> EXISTING CORRUGATED WALL CLADDING
- <X-EL6> EXISTING ALUMINIUM WALL CLADDING
- <X-COM1> EXISTING PRECAST PANEL
- <X-EL7> EXISTING FIBRE GLASS FASCIA LINING
- <X-EL8> EXISTING RIPPLE IRON SOFFIT LINING
- <X-AM1> EXISTING METAL CAPPING
- <X-SN1> ORIGINAL STONE CLADDING
- <X-AM2> EXISTING ALUMINIUM LOUVRE
- <X-AM3> EXISTING METAL SCREEN
- <X-RS1> EXISTING ROOF SHEETING - TYPE 1
- <X-RS2> EXISTING ROOF SHEETING - TYPE 2
- <X-RS3> EXISTING ROOF SHEETING - TYPE 3
- <X-EL1> EXISTING METAL WALL CLADDING
- <M-P24a> EXTERIOR PAINT FINISH - EXISTING METAL WALL CLADDING
- <X-COM2> EXTERIOR PAINT FINISH - EXISTING BLOCKWORK WALL
- <X-CL1> ORIGINAL TIMBER SLAT CEILING
- <X-SK1> ORIGINAL TERRAZZO SKIRTING
- <M-SK5> NEW TERRAZZO SKIRTING TO MATCH EXISTING
- <EL-03> NEW PERFORATED STEEL SCREEN
- <EL-04> NEW POWDER COATED STEEL COLUMNS

CEILING LEGEND:

- X-COL EXISTING CONCRETE COLUMN

GENERAL NOTES:

1. DRAWINGS OF A LARGER SCALE TAKE PRECEDENCE OVER DRAWINGS AT A SMALLER SCALE.
2. ALL EXISTING STRUCTURAL MEMBERS AND FACADE CONSTRUCTION ARE INDICATIVE ONLY. CONTRACTOR IS TO CONFIRM ON SITE EXISTING CONDITION, LEVELS, SIZES AND FIRE RATING TREATMENT.
3. DO NOT SCALE OFF DRAWINGS. USE DIMENSIONS ONLY.
4. ALL DIMENSIONS ARE NOMINAL ONLY. CONTRACTOR TO CONFIRM ALL BUILT AND PROPOSED DIMENSIONS ON SITE PRIOR TO MANUFACTURE OR PREPARING SHOP DRAWINGS.
5. CONTRACTOR IS TO CHECK AND CONFIRM EXISTING CONDITIONS ON SITE, LEVELS, ALIGNMENTS, EXISTING RETAINED STRUCTURE AND ALL OTHER NECESSARY INFORMATION, PRIOR TO COMMENCING ANY WORKS. NOTIFY THE SUPERINTENDENT OF ANY OMISSIONS OR DISCREPANCIES AND SEEK WRITTEN ADVICE PRIOR TO PROCEEDING.

SCOPE NOTES:

1. CLEAN, PREPARE AND PAINT ALL SURFACES WITHIN THE SCOPE OF WORKS AREA, INCLUDING BUT NOT LIMITED TO CONCRETE FACADE ELEMENTS, EXPOSED STRUCTURE AND SERVICES, RAINWATER GOODS AND CLADDING. PROVIDE DETAILED SHOP DRAWINGS INCLUDING BUT NOT LIMITED TO: WINDOWS, DOORS, JOINERY, PARTITION SYSTEMS, CLADDING SYSTEM AND FRAMING SYSTEMS
2. INSTALL NEW HIGH PERFORMANCE ALUMINIUM WINDOWS TO EXTENT INDICATED ON DRAWINGS.
3. INSTALL WINDOW SILLS AND ALUMINIUM TRIMS TO PERIMETER OF SPANDRELS CAVITY.
4. INSTALL NEW MECHANICAL LOUVERS AS SHOWN.
5. INSTALL NEW ROOF AND FACADE ACCESS SYSTEM, REFER ROOF PLAN.
6. INSTALL NON-COMBUSTIBLE ALUMINIUM CLADDING TO THE CENTRAL LIFT TO GROUND FLOOR.

WORKS NOTES:

1. SETOUT IS TO BE IN ACCORDANCE WITH ARCHITECTURAL DRAWINGS
2. ALL DESIGN AND INSTALLATION OF ROOFING TO COMPLY WITH AS1562.1.
3. ALL ROOF PLUMBING TO COMPLY WITH AS/NZS 3500.3.2.
4. ALL RAIN WATER GOODS MATERIAL TO COMPLY WITH AS/NZS 2179.1.
5. ALL FLASHING AND CAPPING TO COMPLY WITH AS/NZS 2904.
6. REFER SERVICES ENGINEERS DOCUMENTATION FOR PROPOSED WORKS TO AND CONNECTION TO EXISTING SERVICES. BEFORE COMMENCING WORKS INSPECT THE SITE AND OBTAIN MEASUREMENTS AND OTHER NECESSARY INFORMATION AS REQUIRED
7. ALL NEW SERVICES RETICULATION TO BE CONCEALED

ACOUSTIC ENGINEERING
Cundall
Level 8 / 350 Queen Street
Melbourne, VIC 3000
T (03) 9635 3700
cundall.com

BUILDING SURVEYOR
Steve Watson & Partners
Level 5 / 369 Royal Parade
Melbourne, VIC 3000
T (03) 9380 5558
swpartners.com.au

BUILDING SERVICES ENGINEER + ESD
WSP
Level 15/28 Freshwater Place
Southbank, Vic 3006
T (03) 9861 1111
wsp.com

CIVIL, FACADE & STRUCTURE ENGINEERING
WSP
Level 15/28 Freshwater Place
Southbank, Vic 3006
T (03) 9861 1111
wsp.com

DDA CONSULTANT
Architecture & Access
Level 5 / 369 Royal Parade
Parkville, VIC 3052
T 1300 715 866
architectureandaccess.com.au

REV.	DETAILS	DATE
1	TOWN PLANNING	22/09/21



PROJECT
MONASH MENZIES REDEVELOPMENT - STAGE 2
MONASH UNIVERSITY CLAYTON CAMPUS

DRAWING TITLE
PROPOSED COLONNADE REFLECTED CEILING PLAN


FOR APPROVAL
DESIGN DEVELOPMENT

SCALE
1:200@A1

JOB No. DRAWN CHECKED DATE
MM08 VK MT SEPT 2021

DRAWING No. REVISION
CL_11_00_A_3245 1

ALL DIMENSIONS ARE IN MILLIMETERS. DO NOT SCALE DRAWINGS FOR CRITICAL DIMENSIONS. CHECK DRAWING IS TO SCALE BY MEASURING SCALE BAR BELOW. VERIFY ALL DIMENSIONS ON SITE BEFORE COMMENCING ANY WORK. SHOP DRAWINGS OR ORDERING MATERIALS.

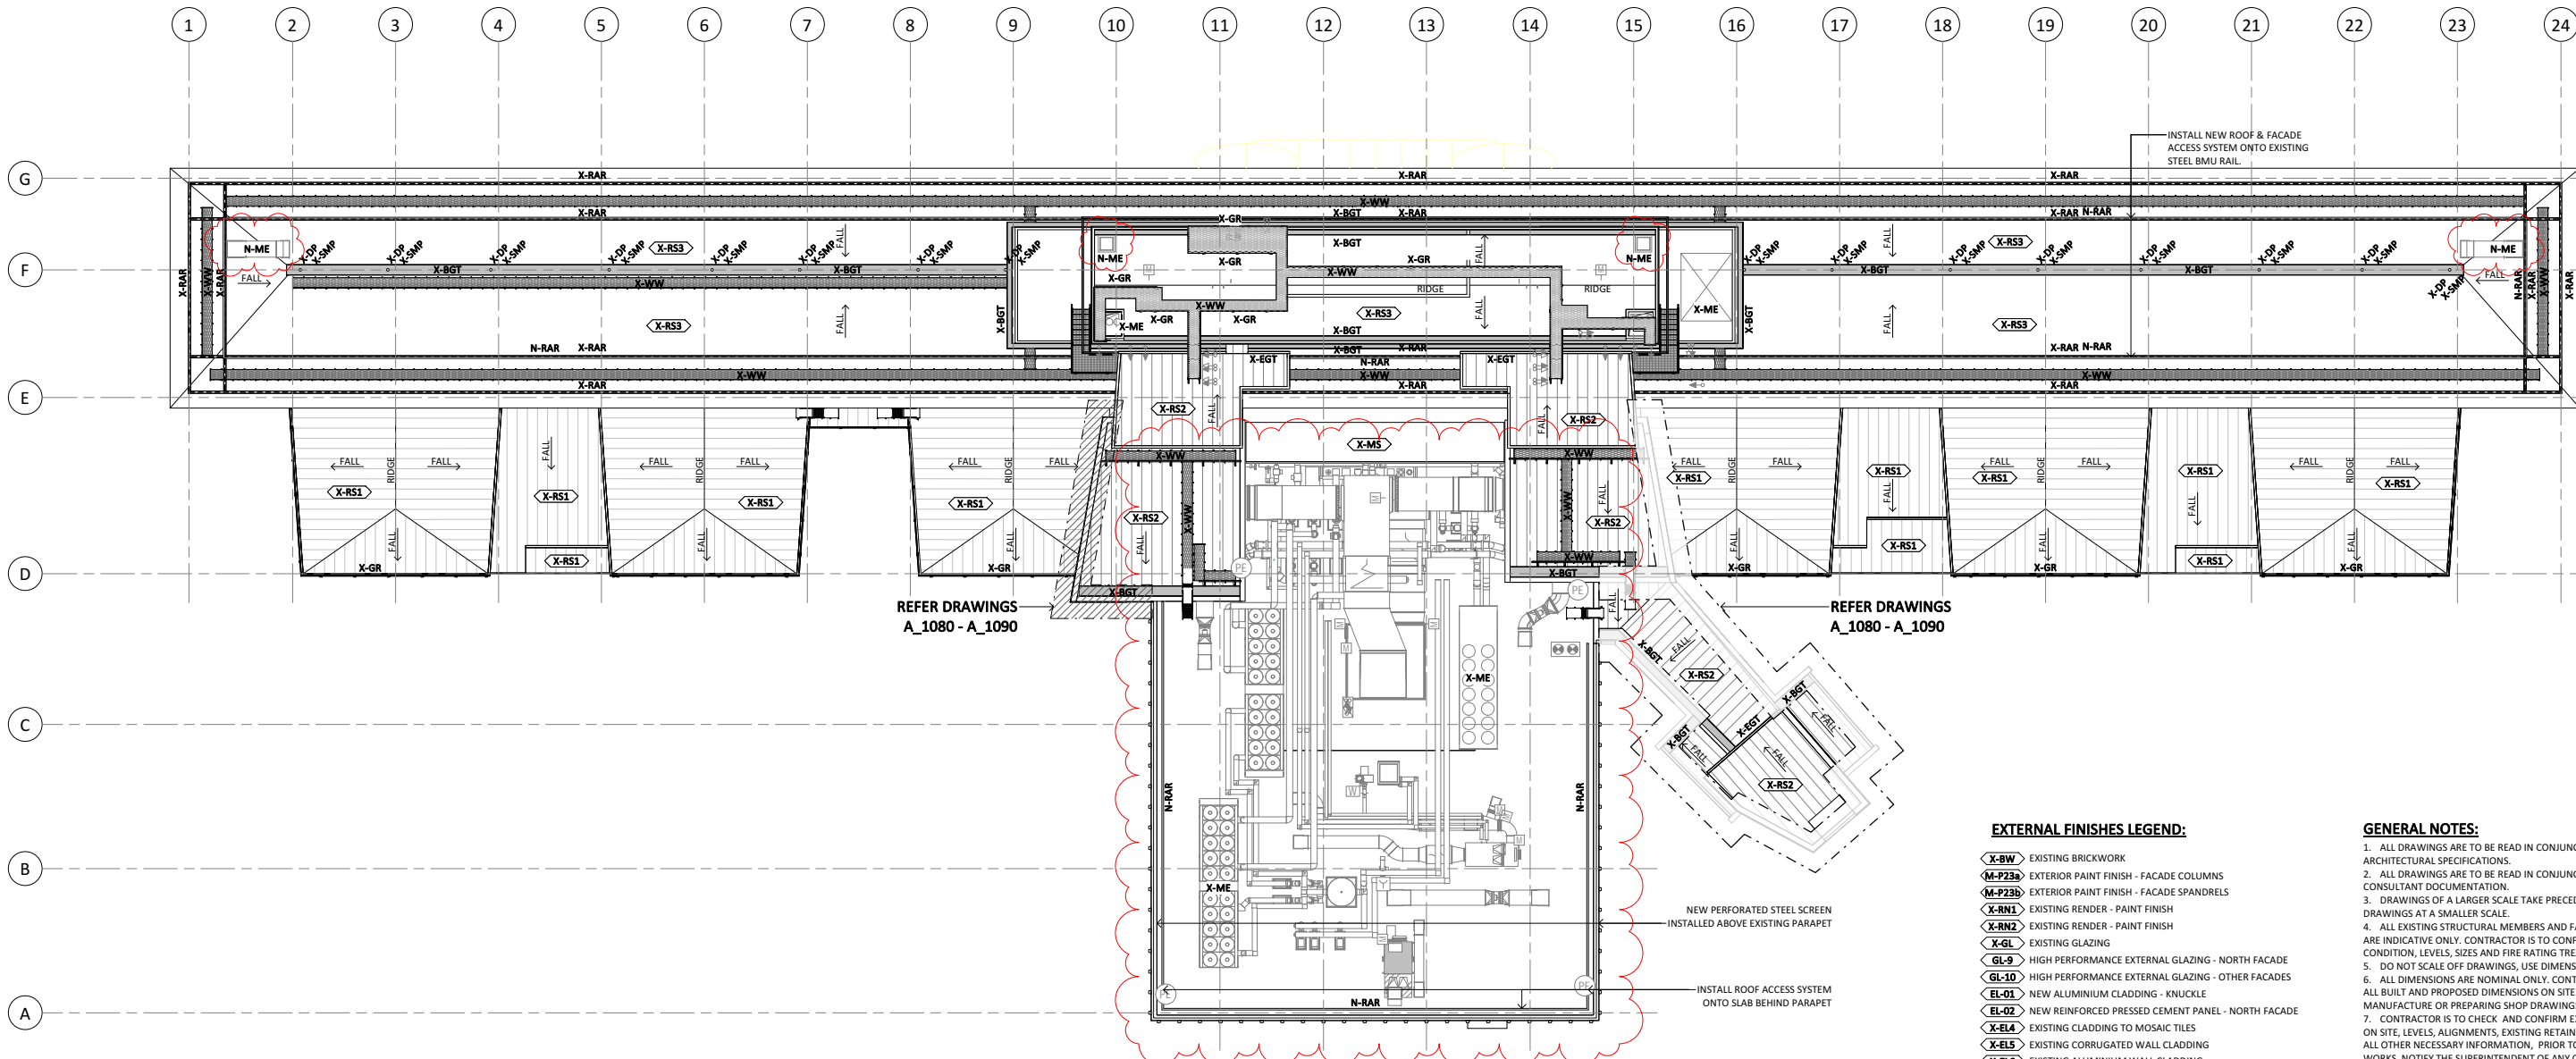

01 ROOF PLAN - PROPOSED
SCALE 1 : 200

- EXTERNAL FINISHES LEGEND:**
- X-BW EXISTING BRICKWORK
 - M-P23a EXTERIOR PAINT FINISH - FACADE COLUMNS
 - M-P23b EXTERIOR PAINT FINISH - FACADE SPANDRELS
 - X-RN1 EXISTING RENDER - PAINT FINISH
 - X-RN2 EXISTING RENDER - PAINT FINISH
 - X-GL EXISTING GLAZING
 - GL-9 HIGH PERFORMANCE EXTERNAL GLAZING - NORTH FACADE
 - GL-10 HIGH PERFORMANCE EXTERNAL GLAZING - OTHER FACADES
 - EL-01 NEW ALUMINIUM CLADDING - KNUCKLE
 - EL-02 NEW REINFORCED PRESSED CEMENT PANEL - NORTH FACADE
 - X-EL4 EXISTING CLADDING TO MOSAIC TILES
 - X-EL5 EXISTING CORRUGATED WALL CLADDING
 - X-EL6 EXISTING ALUMINIUM WALL CLADDING
 - X-CO1 EXISTING PRECAST PANEL
 - X-EL7 EXISTING FIBRE GLASS FASCIA LINING
 - X-EL8 EXISTING RIBBLE IRON SOFFIT LINING
 - X-AM1 EXISTING METAL CAPPING
 - X-SN1 ORIGINAL STONE CLADDING
 - X-AM2 EXISTING ALUMINIUM LOUVRE
 - X-AM3 EXISTING METAL SCREEN
 - X-RS1 EXISTING ROOF SHEETING - TYPE 1
 - X-RS2 EXISTING ROOF SHEETING - TYPE 2
 - X-RS3 EXISTING ROOF SHEETING - TYPE 3
 - X-EL1 EXISTING METAL WALL CLADDING
 - M-P24a EXTERIOR PAINT FINISH - EXISTING METAL WALL CLADDING
 - X-CO2 EXTERIOR PAINT FINISH - EXISTING BLOCKWORK WALL
 - X-CL1 ORIGINAL TIMBER SLAT CEILING
 - X-SK1 ORIGINAL TERRAZZO SKIRTING
 - M-SK3 NEW TERRAZZO SKIRTING TO MATCH EXISTING
 - EL-03 NEW PERFORATED STEEL SCREEN
 - EL-04 NEW POWDER COATED STEEL COLUMNS
 - N-AM2 NEW ALUMINIUM LOUVRE
- ROOF LEGEND:**
- X-WW EXISTING WALKWAYS
 - X-GR EXISTING GUARDRAILS
 - X-ME EXISTING MECHANICAL EQUIPMENT
 - N-ME NEW MECHANICAL EQUIPMENT. REFER TO MECH. ENGR'S DOCUMENTATION
 - X-RF EXISTING ROOF FAN
 - X-BGT EXISTING BOX GUTTER
 - X-SMP EXISTING SUMP
 - X-DP EXISTING DOWNPIPE
 - X-EGT EXISTING EAVES GUTTER
 - N-RAR NEW FACADE ACCESS RAIL
 - X-RAR EXISTING BMU RAIL

- GENERAL NOTES:**
- ALL DRAWINGS ARE TO BE READ IN CONJUNCTION WITH THE ARCHITECTURAL SPECIFICATIONS.
 - ALL DRAWINGS ARE TO BE READ IN CONJUNCTION WITH ALL CONSULTANT DOCUMENTATION.
 - DRAWINGS OF A LARGER SCALE TAKE PRECEDENCE OVER DRAWINGS AT A SMALLER SCALE.
 - ALL EXISTING STRUCTURAL MEMBERS AND FACADE CONSTRUCTION ARE INDICATIVE ONLY. CONTRACTOR IS TO CONFIRM ON SITE EXISTING CONDITION, LEVELS, SIZES AND FIRE RATING TREATMENT.
 - DO NOT SCALE OFF DRAWINGS, USE DIMENSIONS ONLY.
 - ALL DIMENSIONS ARE NOMINAL ONLY. CONTRACTOR TO CONFIRM ALL BUILT AND PROPOSED DIMENSIONS ON SITE PRIOR TO MANUFACTURE OR PREPARING SHOP DRAWINGS.
 - CONTRACTOR IS TO CHECK AND CONFIRM EXISTING CONDITIONS ON SITE, LEVELS, ALIGNMENTS, EXISTING RETAINED STRUCTURE AND ALL OTHER NECESSARY INFORMATION, PRIOR TO COMMENCING ANY WORKS. NOTIFY THE SUPERINTENDENT OF ANY OMISSIONS OR DISCREPANCIES AND SEEK WRITTEN ADVICE PRIOR TO PROCEEDING.

- SCOPE NOTES:**
- CLEAN, PREPARE AND PAINT ALL SURFACES WITHIN THE SCOPE OF WORKS AREA, INCLUDING BUT NOT LIMITED TO CONCRETE FACADE ELEMENTS, EXPOSED STRUCTURE AND SERVICES, RAINWATER GOODS AND CLADDING PROVIDE DETAILED SHOP DRAWINGS INCLUDING BUT NOT LIMITED TO: WINDOWS, DOORS, JOINERY, PARTITION SYSTEMS, CLADDING SYSTEM AND FRAMING SYSTEMS
 - INSTALL NEW HIGH PERFORMANCE ALUMINIUM WINDOWS TO EXTENT INDICATED ON DRAWINGS.
 - INSTALL WINDOW SILLS AND ALUMINIUM TRIMS TO PERIMETER OF SPANDRELS CAVITY.
 - INSTALL NEW MECHANICAL LOUVERS AS SHOWN.
 - INSTALL NEW ROOF AND FACADE ACCESS SYSTEM, REFER ROOF PLAN.
 - INSTALL NON-COMBUSTIBLE ALUMINIUM CLADDING TO THE CENTRAL LIFT TO GROUND FLOOR.

- WORKS NOTES:**
- SETOUT IS TO BE IN ACCORDANCE WITH ARCHITECTURAL DRAWINGS
 - ALL DESIGN AND INSTALLATION OF ROOFING TO COMPLY WITH AS1562.1.
 - ALL ROOF PLUMBING TO COMPLY WITH AS/NZS 3500.3.2.
 - ALL RAIN WATER GOODS MATERIAL TO COMPLY WITH AS/NZS 2179.1.
 - ALL FLASHING AND CAPPING TO COMPLY WITH AS/NZS 2904.
 - REFER SERVICES ENGINEERS DOCUMENTATION FOR PROPOSED WORKS TO AND CONNECTION TO EXISTING SERVICES. BEFORE COMMENCING WORKS INSPECT THE SITE AND OBTAIN MEASUREMENTS AND OTHER NECESSARY INFORMATION AS REQUIRED
 - ALL NEW SERVICES RETICULATION TO BE CONCEALED

ACOUSTIC ENGINEERING
Cundall
Level 6 | 350 Queen Street
Melbourne, VIC 3000
T (03) 9635 3700
cundall.com

BUILDING SURVEYOR
Steve Watson & Partners
Level 6 | 350 Queen Street
Melbourne, VIC 3000
T (03) 9380 5558
swpartners.com.au

BUILDING SERVICES ENGINEER + ESD
WSP
Level 15/28 Freshwater Place
Southbank, Vic 3006
T (03) 9861 1111
wsp.com

CIVIL, FACADE & STRUCTURE ENGINEERING
WSP
Level 15/28 Freshwater Place
Southbank, Vic 3006
T (03) 9861 1111
wsp.com

DDA CONSULTANT
Architecture & Access
Level 5 | 369 Royal Parade
Parkville, VIC 3052
T 1300 715 866
architectureandaccess.com.au

REV.	DETAILS	DATE
3	TOWN PLANNING	25/11/2021
2	TOWN PLANNING	22/09/2021
1	SCHEMATIC DESIGN	30/08/2021



PROJECT
MONASH MENZIES REDEVELOPMENT - STAGE 2
MONASH UNIVERSITY CLAYTON CAMPUS

DRAWING TITLE
PROPOSED ROOF PLAN

NORTH

FOR APPROVAL
TOWN PLANNING


SCALE
1:200@A1

JOB No. DRAWN CHECKED DATE
MM08 VK MT SEPT 2021


DRAWING No. REVISION
CL_11_A_3246 3

ALL DIMENSIONS ARE IN MILLIMETERS. DO NOT SCALE DRAWINGS FOR CRITICAL DIMENSIONS. CHECK DRAWING IS TO SCALE BY MEASURING SCALE BAR BELOW. VERIFY ALL DIMENSIONS ON SITE BEFORE COMMENCING ANY WORK. SHOP DRAWINGS OR ORDERING MATERIALS.

24 23 22 21 20 19 18 17 16 15 14 13 12 11 10 9 8 7 6 5 4 3 2 1

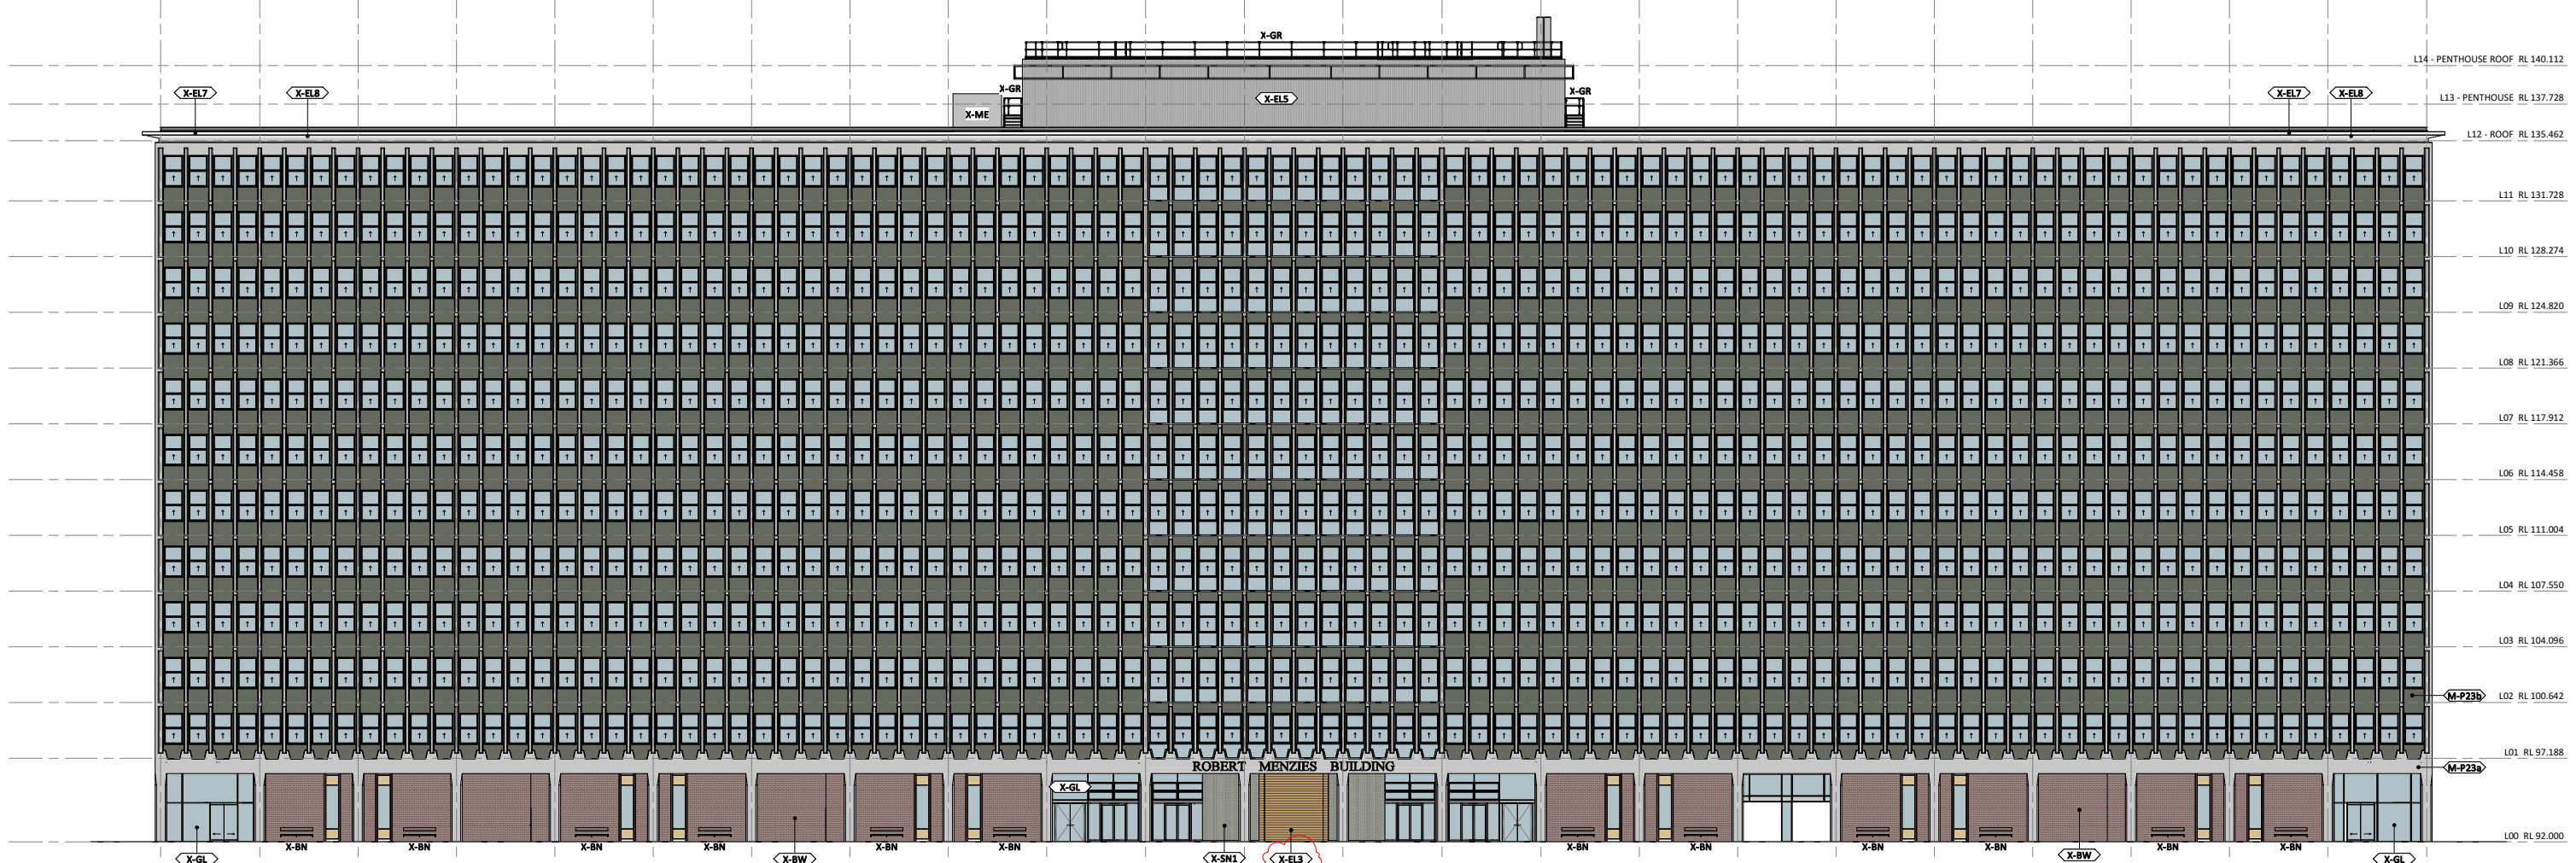

01 ELEVATION - NORTH - EXISTING CONDITION
SCALE 1 : 200

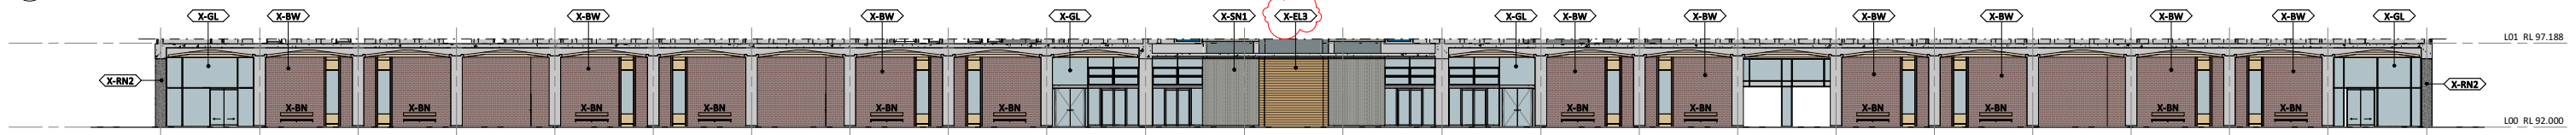

02 ELEVATION - NORTH COLONNADE - EXISTING CONDITION
SCALE 1 : 200

EXTERNAL FINISHES LEGEND:

- X-BW EXISTING BRICKWORK
- M-P23a EXISTING PAINT FINISH - FACADE COLUMNS
- M-P23b EXISTING PAINT FINISH - FACADE SPANDRELS
- X-RN1 EXISTING RENDER - PAINT FINISH
- X-RN2 EXISTING RENDER - PAINT FINISH
- X-GL EXISTING GLAZING
- X-EL3 EXISTING TIMBER CLADDING
- X-EL4 EXISTING CLADDING TO MOSAIC TILES
- X-EL5 EXISTING CORRUGATED WALL CLADDING
- X-EL6 EXISTING ALUMINIUM WALL CLADDING
- X-CON1 EXISTING PRECAST PANEL
- X-EL7 EXISTING FIBRE GLASS FASCIA LINING
- X-EL8 EXISTING RIPPLE IRON SOFFIT LINING
- X-AM1 EXISTING METAL CAPPING
- X-SN1 ORIGINAL STONE CLADDING
- X-AM2 EXISTING ALUMINIUM LOUVRE
- X-AM3 EXISTING METAL SCREEN
- X-RS1 EXISTING ROOF SHEETING - TYPE 1
- X-RS2 EXISTING ROOF SHEETING - TYPE 2
- X-RS3 EXISTING ROOF SHEETING - TYPE 3
- X-EL1 EXISTING METAL WALL CLADDING
- X-EL2 EXISTING METAL WALL CLADDING
- M-P24a EXISTING PAINT FINISH - EXISTING METAL WALL CLADDING
- X-CON2 EXISTING PAINT FINISH - EXISTING BLOCKWORK WALL
- X-CL1 ORIGINAL TIMBER SLAT CEILING

FACADES LEGEND:

- X-BN EXISTING BENCHES
- X-GR EXISTING GUARDRAILS
- X-ME EXISTING MECHANICAL EQUIPMENT

GENERAL NOTES:

1. ALL DRAWINGS ARE TO BE READ IN CONJUNCTION WITH THE ARCHITECTURAL SPECIFICATIONS.
2. ALL DRAWINGS ARE TO BE READ IN CONJUNCTION WITH ALL CONSULTANT DOCUMENTATION.
3. DRAWINGS OF A LARGER SCALE TAKE PRECEDENCE OVER DRAWINGS AT A SMALLER SCALE.
4. ALL EXISTING STRUCTURAL MEMBERS AND FACADE CONSTRUCTION ARE INDICATIVE ONLY. CONTRACTOR IS TO CONFIRM ON SITE EXISTING CONDITION, LEVELS, SIZES AND FIRE RATING TREATMENT.
5. DO NOT SCALE OFF DRAWINGS, USE DIMENSIONS ONLY.
6. ALL DIMENSIONS ARE NOMINAL ONLY. CONTRACTOR TO CONFIRM ALL BUILT AND PROPOSED DIMENSIONS ON SITE PRIOR TO MANUFACTURE OR PREPARING SHOP DRAWINGS.
7. CONTRACTOR IS TO CHECK AND CONFIRM EXISTING CONDITIONS ON SITE, LEVELS, ALIGNMENTS, EXISTING RETAINED STRUCTURE AND ALL OTHER NECESSARY INFORMATION, PRIOR TO COMMENCING ANY WORKS. NOTIFY THE SUPERINTENDENT OF ANY OMISSIONS OR DISCREPANCIES AND SEEK WRITTEN ADVICE PRIOR TO PROCEEDING.

ACOUSTIC ENGINEERING
Cundall
Level 6 / 330 Queen Street
Melbourne, VIC 3000
T (03) 9635 3700
cundall.com

BUILDING SURVEYOR
Steve Watson & Partners
Level 6 / 330 Queen Street
Melbourne, VIC 3000
T (03) 9380 5558
swpartners.com.au

BUILDING SERVICES ENGINEER + ESD
WSP
Level 15/28 Freshwater Place
Southbank, Vic 3006
T (03) 9861 1111
wsp.com

CIVIL, FACADE & STRUCTURE ENGINEERING
WSP
Level 15/28 Freshwater Place
Southbank, Vic 3006
T (03) 9861 1111
wsp.com

DDA CONSULTANT
Architecture & Access
Level 5 / 369 Royal Parade
Parkville, VIC 3052
T 1300 715 866
architectureandaccess.com.au

REV.	DETAILS	DATE
3	TOWN PLANNING	25/11/2021
2	TOWN PLANNING	22/09/2021
1	SCHEMATIC DESIGN	30/08/2021



PROJECT
MONASH MENZIES REDEVELOPMENT - STAGE 2
MONASH UNIVERSITY CLAYTON CAMPUS

DRAWING TITLE
ELEVATIONS - NORTH - EXISTING

NORTH


FOR APPROVAL
TOWN PLANNING

SCALE
1:200@A1


JOB No. DRAWN CHECKED DATE
MM08 VK MT SEPT 2021

DRAWING No. REVISION
CL_11_A_6001 3

ALL DIMENSIONS ARE IN MILLIMETERS. DO NOT SCALE DRAWINGS FOR CRITICAL DIMENSIONS. CHECK DRAWING IS TO SCALE BY MEASURING SCALE BAR BELOW. VERIFY ALL DIMENSIONS ON SITE BEFORE COMMENCING ANY WORK, SHOP DRAWINGS OR ORDERING MATERIALS.

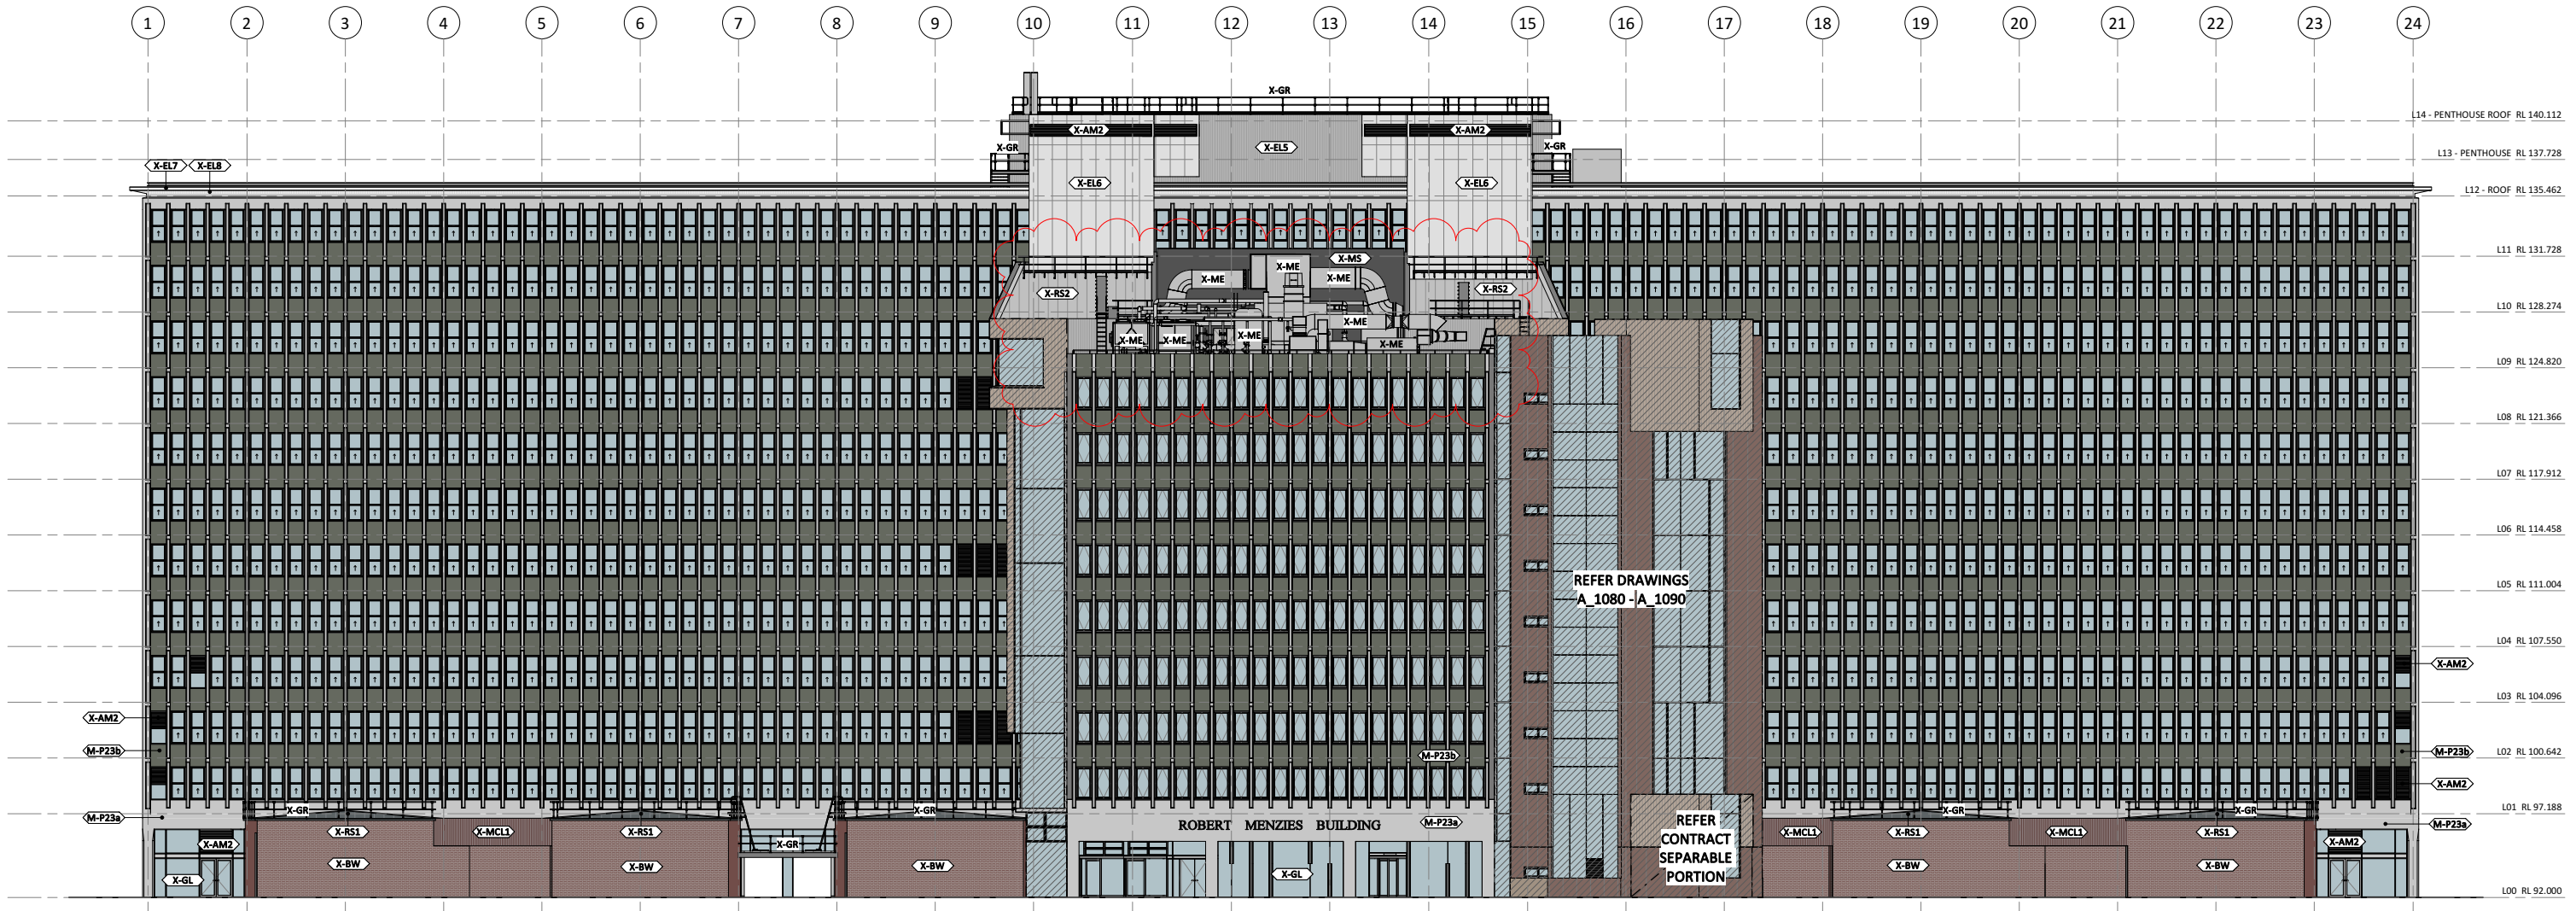

01 ELEVATION - SOUTH - EXISTING CONDITION
SCALE 1 : 200

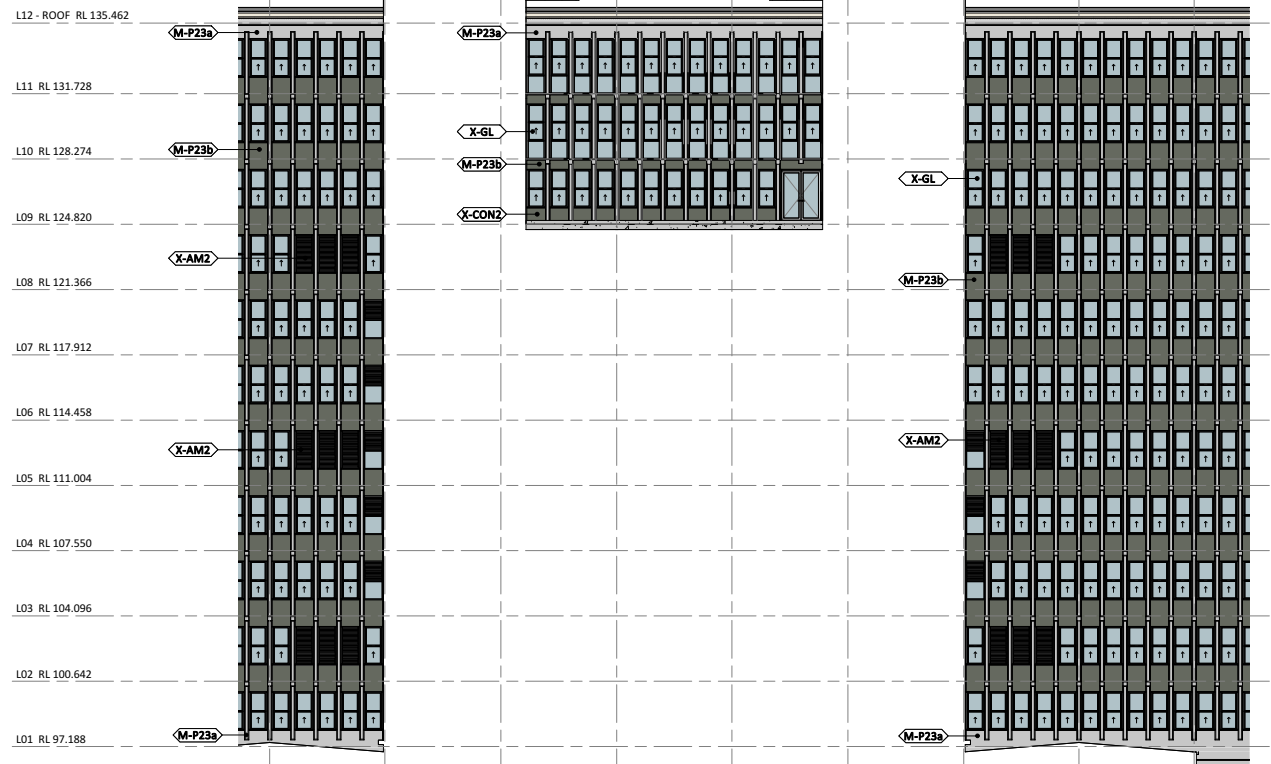

02 ELEVATION - SOUTH - BEYOND LIFT TOWER - EXISTING CONDITION
SCALE 1 : 200

- EXTERNAL FINISHES LEGEND:**
- X-BW EXISTING BRICKWORK
 - M-P23a EXISTING PAINT FINISH - FACADE COLUMNS
 - M-P23b EXISTING PAINT FINISH - FACADE SPANDRELS
 - X-RN1 EXISTING RENDER - PAINT FINISH
 - X-RN2 EXISTING RENDER - PAINT FINISH
 - X-GL EXISTING GLAZING
 - X-EL3 EXISTING TIMBER CLADDING
 - X-EL4 EXISTING CLADDING TO MOSAIC TILES
 - X-EL5 EXISTING CORRUGATED WALL CLADDING
 - X-EL6 EXISTING ALUMINIUM WALL CLADDING
 - X-CON1 EXISTING PRECAST PANEL
 - X-EL7 EXISTING FIBRE GLASS FASCIA LINING
 - X-EL8 EXISTING RIPPLE IRON SOFFIT LINING
 - X-AM1 EXISTING METAL CAPPING
 - X-SN1 ORIGINAL STONE CLADDING
 - X-AM2 EXISTING ALUMINIUM LOUVRE
 - X-AM3 EXISTING METAL SCREEN
 - X-RS1 EXISTING ROOF SHEETING - TYPE 1
 - X-RS2 EXISTING ROOF SHEETING - TYPE 2
 - X-RS3 EXISTING ROOF SHEETING - TYPE 3
 - X-EL1 EXISTING METAL WALL CLADDING
 - X-EL2 EXISTING METAL WALL CLADDING
 - M-P24a EXISTING PAINT FINISH - EXISTING METAL WALL CLADDING
 - X-CON2 EXISTING PAINT FINISH - EXISTING BLOCKWORK WALL
 - X-CL1 ORIGINAL TIMBER SLAT CEILING
- FACADES LEGEND:**
- X-BN EXISTING BENCHES
 - X-GR EXISTING GUARDRAILS
 - X-ME EXISTING MECHANICAL EQUIPMENT

- GENERAL NOTES:**
1. ALL DRAWINGS ARE TO BE READ IN CONJUNCTION WITH THE ARCHITECTURAL SPECIFICATIONS.
 2. ALL DRAWINGS ARE TO BE READ IN CONJUNCTION WITH ALL CONSULTANT DOCUMENTATION.
 3. DRAWINGS OF A LARGER SCALE TAKE PRECEDENCE OVER DRAWINGS AT A SMALLER SCALE.
 4. ALL EXISTING STRUCTURAL MEMBERS AND FACADE CONSTRUCTION ARE INDICATIVE ONLY. CONTRACTOR IS TO CONFIRM ON SITE EXISTING CONDITION, LEVELS, SIZES AND FIRE RATING TREATMENT.
 5. DO NOT SCALE OFF DRAWINGS, USE DIMENSIONS ONLY.
 6. ALL DIMENSIONS ARE NOMINAL ONLY. CONTRACTOR TO CONFIRM ALL BUILT AND PROPOSED DIMENSIONS ON SITE PRIOR TO MANUFACTURE OR PREPARING SHOP DRAWINGS.
 7. CONTRACTOR IS TO CHECK AND CONFIRM EXISTING CONDITIONS ON SITE, LEVELS, ALIGNMENTS, EXISTING RETAINED STRUCTURE AND ALL OTHER NECESSARY INFORMATION, PRIOR TO COMMENCING ANY WORKS. NOTIFY THE SUPERINTENDENT OF ANY OMISSIONS OR DISCREPANCIES AND SEEK WRITTEN ADVICE PRIOR TO PROCEEDING.

ACOUSTIC ENGINEERING
Cundall
Level 8 / 350 Queen Street
Melbourne, VIC 3000
T (03) 9635 3700
cundall.com

BUILDING SURVEYOR
Steve Watson & Partners
Level 5 / 369 Royal Parade
Parkville, VIC 3052
T (03) 9380 5558
swpartners.com.au

BUILDING SERVICES ENGINEER + ESD
WSP
Level 15/28 Freshwater Place
Southbank, Vic 3006
T (03) 9661 1111
wsp.com

CIVIL, FACADE & STRUCTURE ENGINEERING
WSP
Level 15/28 Freshwater Place
Southbank, Vic 3006
T (03) 9661 1111
wsp.com

DDA CONSULTANT
Architecture & Access
Level 5 / 369 Royal Parade
Parkville, VIC 3052
T 1300 715 866
architectureandaccess.com.au

REV.	DETAILS	DATE
3	TOWN PLANNING	25/11/2021
2	TOWN PLANNING	22/09/2021
1	SCHEMATIC DESIGN	30/08/2021



PROJECT
MONASH MENZIES REDEVELOPMENT - STAGE 2
MONASH UNIVERSITY CLAYTON CAMPUS

DRAWING TITLE
ELEVATIONS - SOUTH - EXISTING


NORTH

FOR APPROVAL
TOWN PLANNING

SCALE
1:200@A1


JOB No.	DRAWN	CHECKED	DATE
MM08	VK	MT	SEPT 2021
DRAWING No.			REVISION
CL_11_A_6002			3

ALL DIMENSIONS ARE IN MILLIMETERS. DO NOT SCALE DRAWINGS FOR CRITICAL DIMENSIONS. CHECK DRAWING IS TO SCALE BY MEASURING SCALE BAR BELOW. VERIFY ALL DIMENSIONS ON SITE BEFORE COMMENCING ANY WORK, SHOP DRAWINGS OR ORDERING MATERIALS.

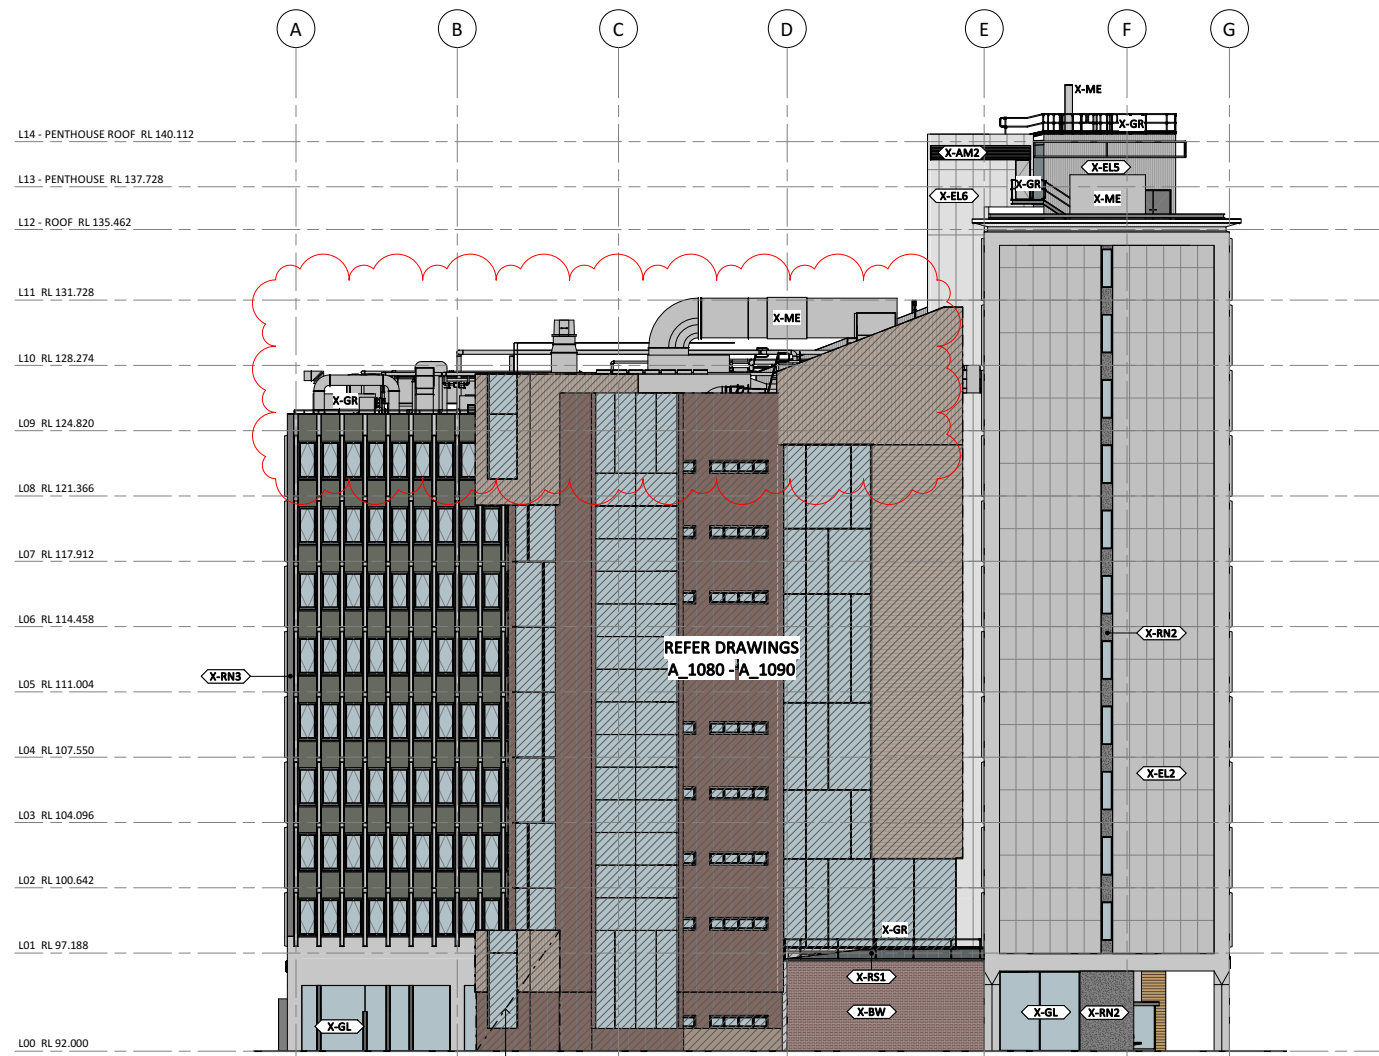

REFER CONTRACT SEPARABLE PORTION

01 ELEVATION - EAST - EXISTING CONDITION
SCALE 1 : 200

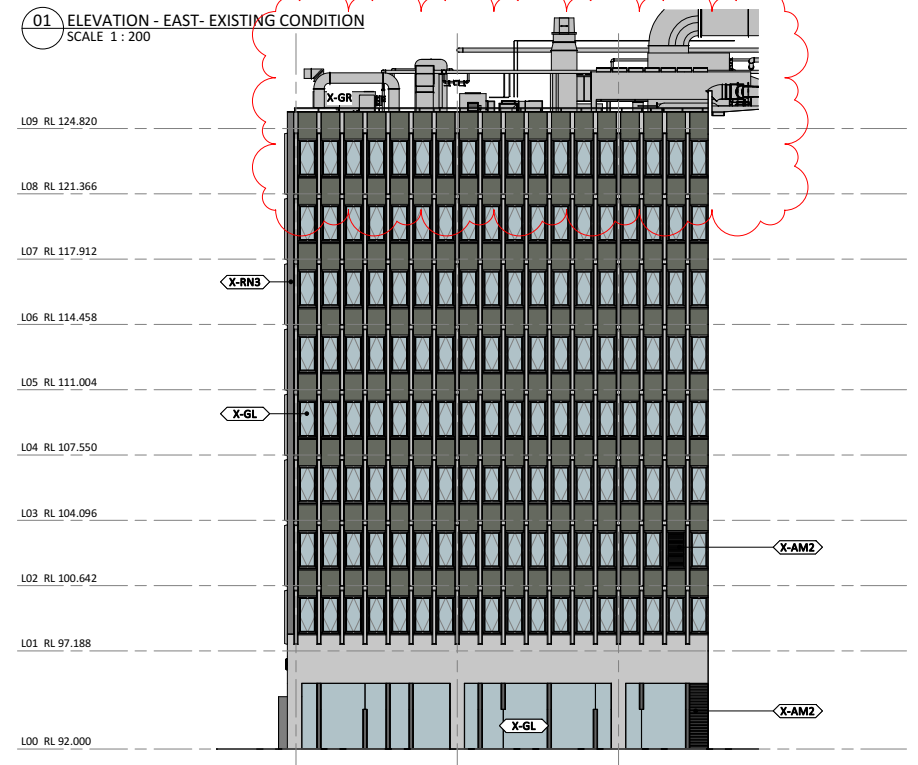

02 ELEVATION - EAST - BEYOND LIFT TOWER - EXISTING CONDITION
SCALE 1 : 200

ACOUSTIC ENGINEERING
Cundall
L2/330 Little Collins Street
Melbourne, VIC 3000
T (03) 9635 3700
cundall.com


BUILDING SURVEYOR
Steve Watson & Partners
Level 6/ 350 Queen Street
Melbourne, VIC 3000
T (03) 9380 5558
swpartners.com.au

BUILDING SERVICES ENGINEER + ESD
WSP
Level 15/28 Freshwater Place
Southbank, Vic 3006
T (03) 9861 1111
wsp.com


CIVIL, FACADE & STRUCTURE ENGINEERING
WSP
Level 15/28 Freshwater Place
Southbank, Vic 3006
T (03) 9861 1111
wsp.com

DDA CONSULTANT
Architecture & Access
Level 5 / 369 Royal Parade
Parkville, VIC 3052
T 1300 715 866
architectureandaccess.com.au

REV.	DETAILS	DATE
3	TOWN PLANNING	25/11/2021
2	TOWN PLANNING	22/09/2021
1	SCHEMATIC DESIGN	30/08/2021

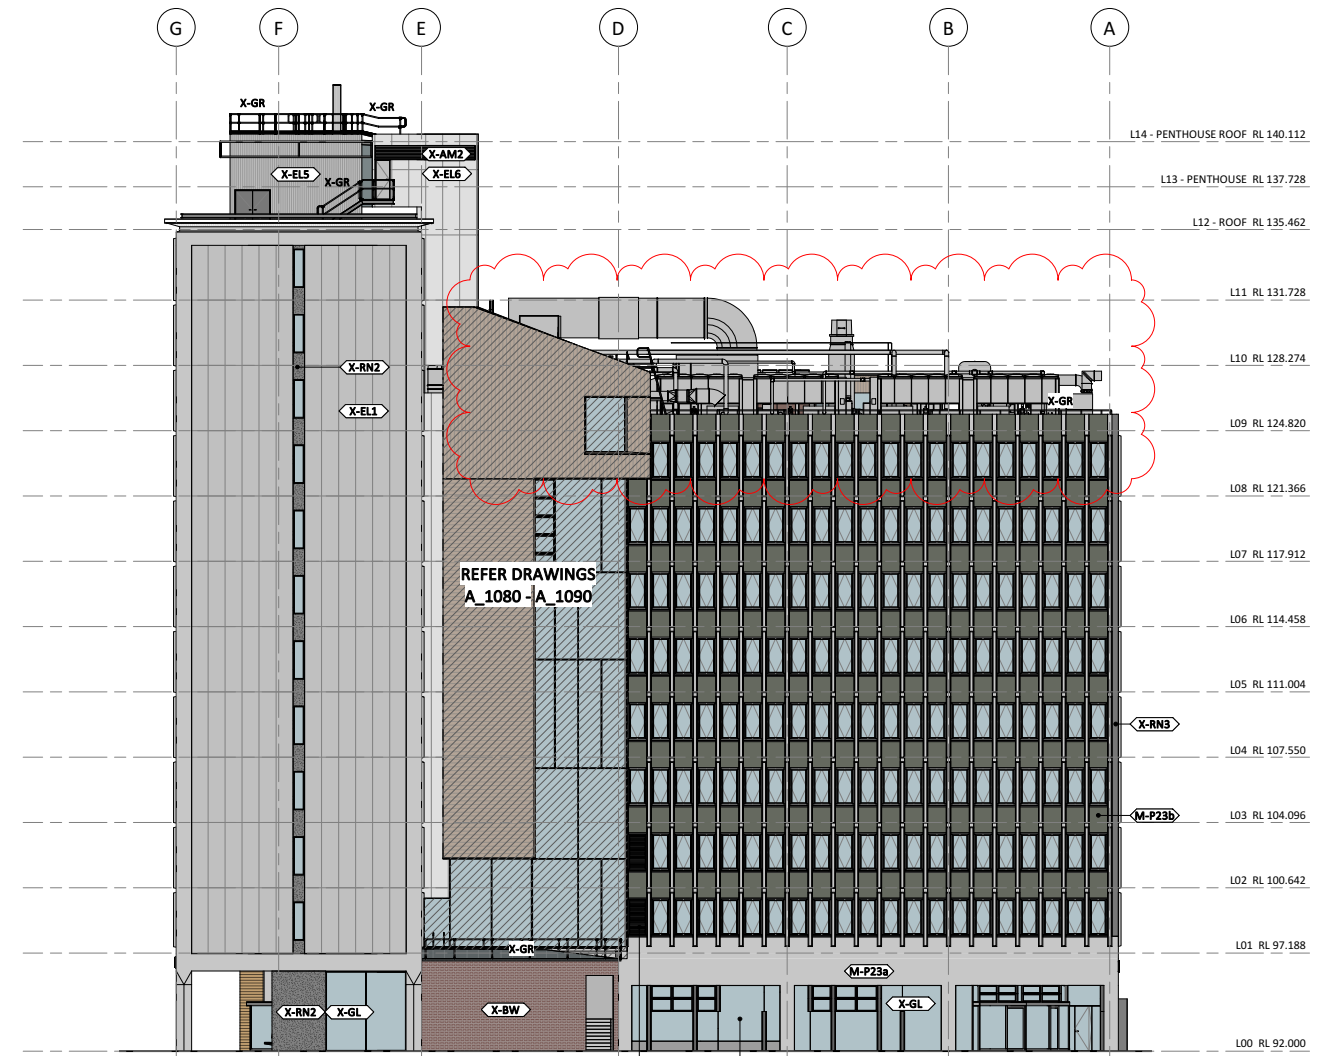

03 ELEVATION - WEST - EXISTING CONDITION
SCALE 1 : 200

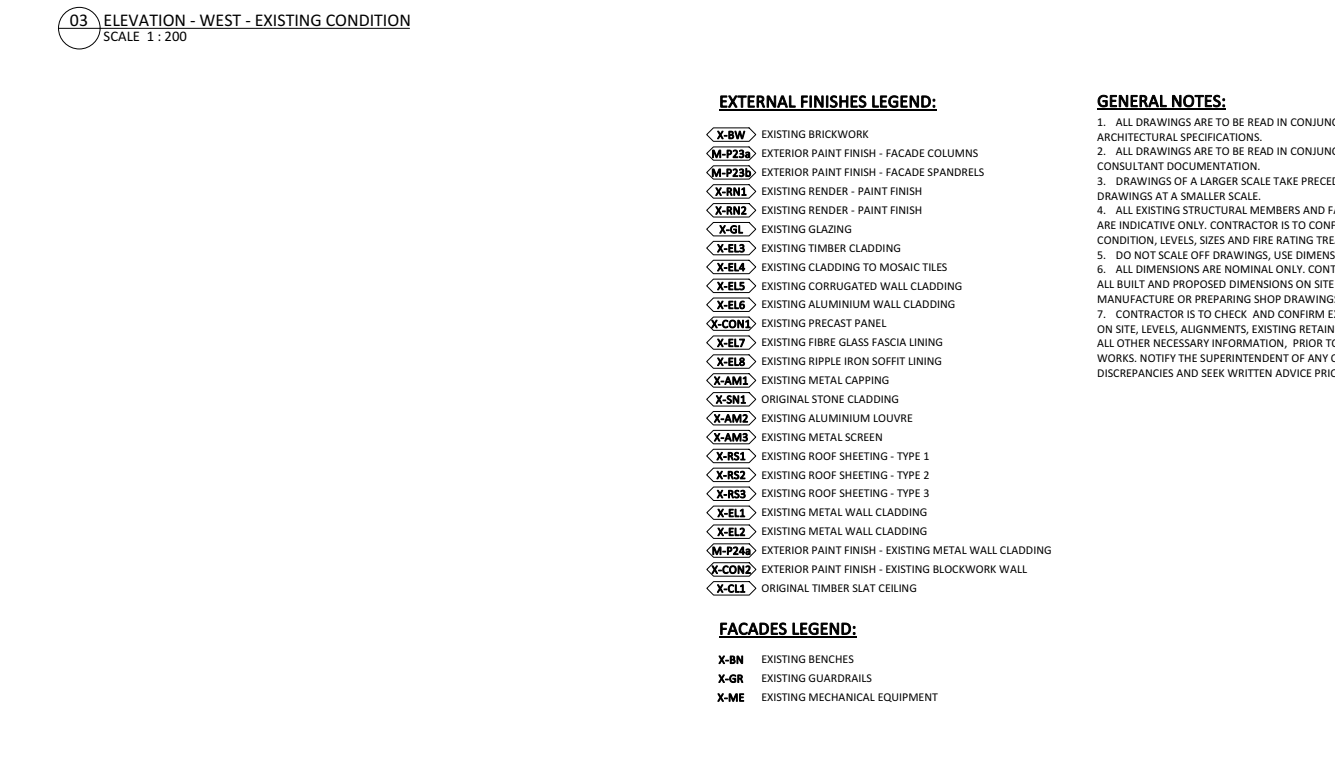

- EXTERNAL FINISHES LEGEND:**
- X-BW EXISTING BRICKWORK
 - M-P23a EXTERIOR PAINT FINISH - FACADE COLUMNS
 - M-P23b EXTERIOR PAINT FINISH - FACADE SPANDRELS
 - X-RN1 EXISTING RENDER - PAINT FINISH
 - X-RN2 EXISTING RENDER - PAINT FINISH
 - X-GL EXISTING GLAZING
 - X-EL3 EXISTING TIMBER CLADDING
 - X-EL4 EXISTING CLADDING TO MOSAIC TILES
 - X-EL5 EXISTING CORRUGATED WALL CLADDING
 - X-EL6 EXISTING ALUMINIUM WALL CLADDING
 - X-CON1 EXISTING PRECAST PANEL
 - X-EL7 EXISTING FIBRE GLASS FASCIA LINING
 - X-EL8 EXISTING RIPPLE IRON SOFFIT LINING
 - X-AM1 EXISTING METAL CAPPING
 - X-SN1 ORIGINAL STONE CLADDING
 - X-AM2 EXISTING ALUMINIUM LOUVRE
 - X-AM3 EXISTING METAL SCREEN
 - X-RS1 EXISTING ROOF SHEETING - TYPE 1
 - X-RS2 EXISTING ROOF SHEETING - TYPE 2
 - X-RS3 EXISTING ROOF SHEETING - TYPE 3
 - X-EL1 EXISTING METAL WALL CLADDING
 - X-EL2 EXISTING METAL WALL CLADDING
 - M-P24a EXTERIOR PAINT FINISH - EXISTING METAL WALL CLADDING
 - X-CON2 EXTERIOR PAINT FINISH - EXISTING BLOCKWORK WALL
 - X-CL1 ORIGINAL TIMBER SLAT CEILING
- FACADES LEGEND:**
- X-BN EXISTING BENCHES
 - X-GR EXISTING GUARDRAILS
 - X-ME EXISTING MECHANICAL EQUIPMENT

- GENERAL NOTES:**
1. ALL DRAWINGS ARE TO BE READ IN CONJUNCTION WITH THE ARCHITECTURAL SPECIFICATIONS.
 2. ALL DRAWINGS ARE TO BE READ IN CONJUNCTION WITH ALL CONSULTANT DOCUMENTATION.
 3. DRAWINGS OF A LARGER SCALE TAKE PRECEDENCE OVER DRAWINGS AT A SMALLER SCALE.
 4. ALL EXISTING STRUCTURAL MEMBERS AND FACADE CONSTRUCTION ARE INDICATIVE ONLY. CONTRACTOR IS TO CONFIRM ON SITE EXISTING CONDITION, LEVELS, ALIGNMENTS, EXISTING RETAINED STRUCTURE AND ALL OTHER NECESSARY INFORMATION, PRIOR TO COMMENCING ANY WORKS. NOTIFY THE SUPERINTENDENT OF ANY OMISSIONS OR DISCREPANCIES AND SEEK WRITTEN ADVICE PRIOR TO PROCEEDING.
 5. DO NOT SCALE OFF DRAWINGS, USE DIMENSIONS ONLY.
 6. ALL DIMENSIONS ARE NOMINAL ONLY. CONTRACTOR TO CONFIRM ALL BUILT AND PROPOSED DIMENSIONS ON SITE PRIOR TO MANUFACTURE OR PREPARING SHOP DRAWINGS.
 7. CONTRACTOR IS TO CHECK AND CONFIRM EXISTING CONDITIONS ON SITE, LEVELS, ALIGNMENTS, EXISTING RETAINED STRUCTURE AND ALL OTHER NECESSARY INFORMATION, PRIOR TO COMMENCING ANY WORKS. NOTIFY THE SUPERINTENDENT OF ANY OMISSIONS OR DISCREPANCIES AND SEEK WRITTEN ADVICE PRIOR TO PROCEEDING.

PROJECT
MONASH MENZIES REDEVELOPMENT - STAGE 2
MONASH UNIVERSITY CLAYTON CAMPUS

DRAWING TITLE
ELEVATIONS - EAST & WEST - EXISTING


NORTH

FOR APPROVAL
TOWN PLANNING


SCALE
1:200@A1

JOB No.	DRAWN	CHECKED	DATE
MM08	VK	MT	SEPT 2021
DRAWING No.			REVISION
CL_11_A_6003			3



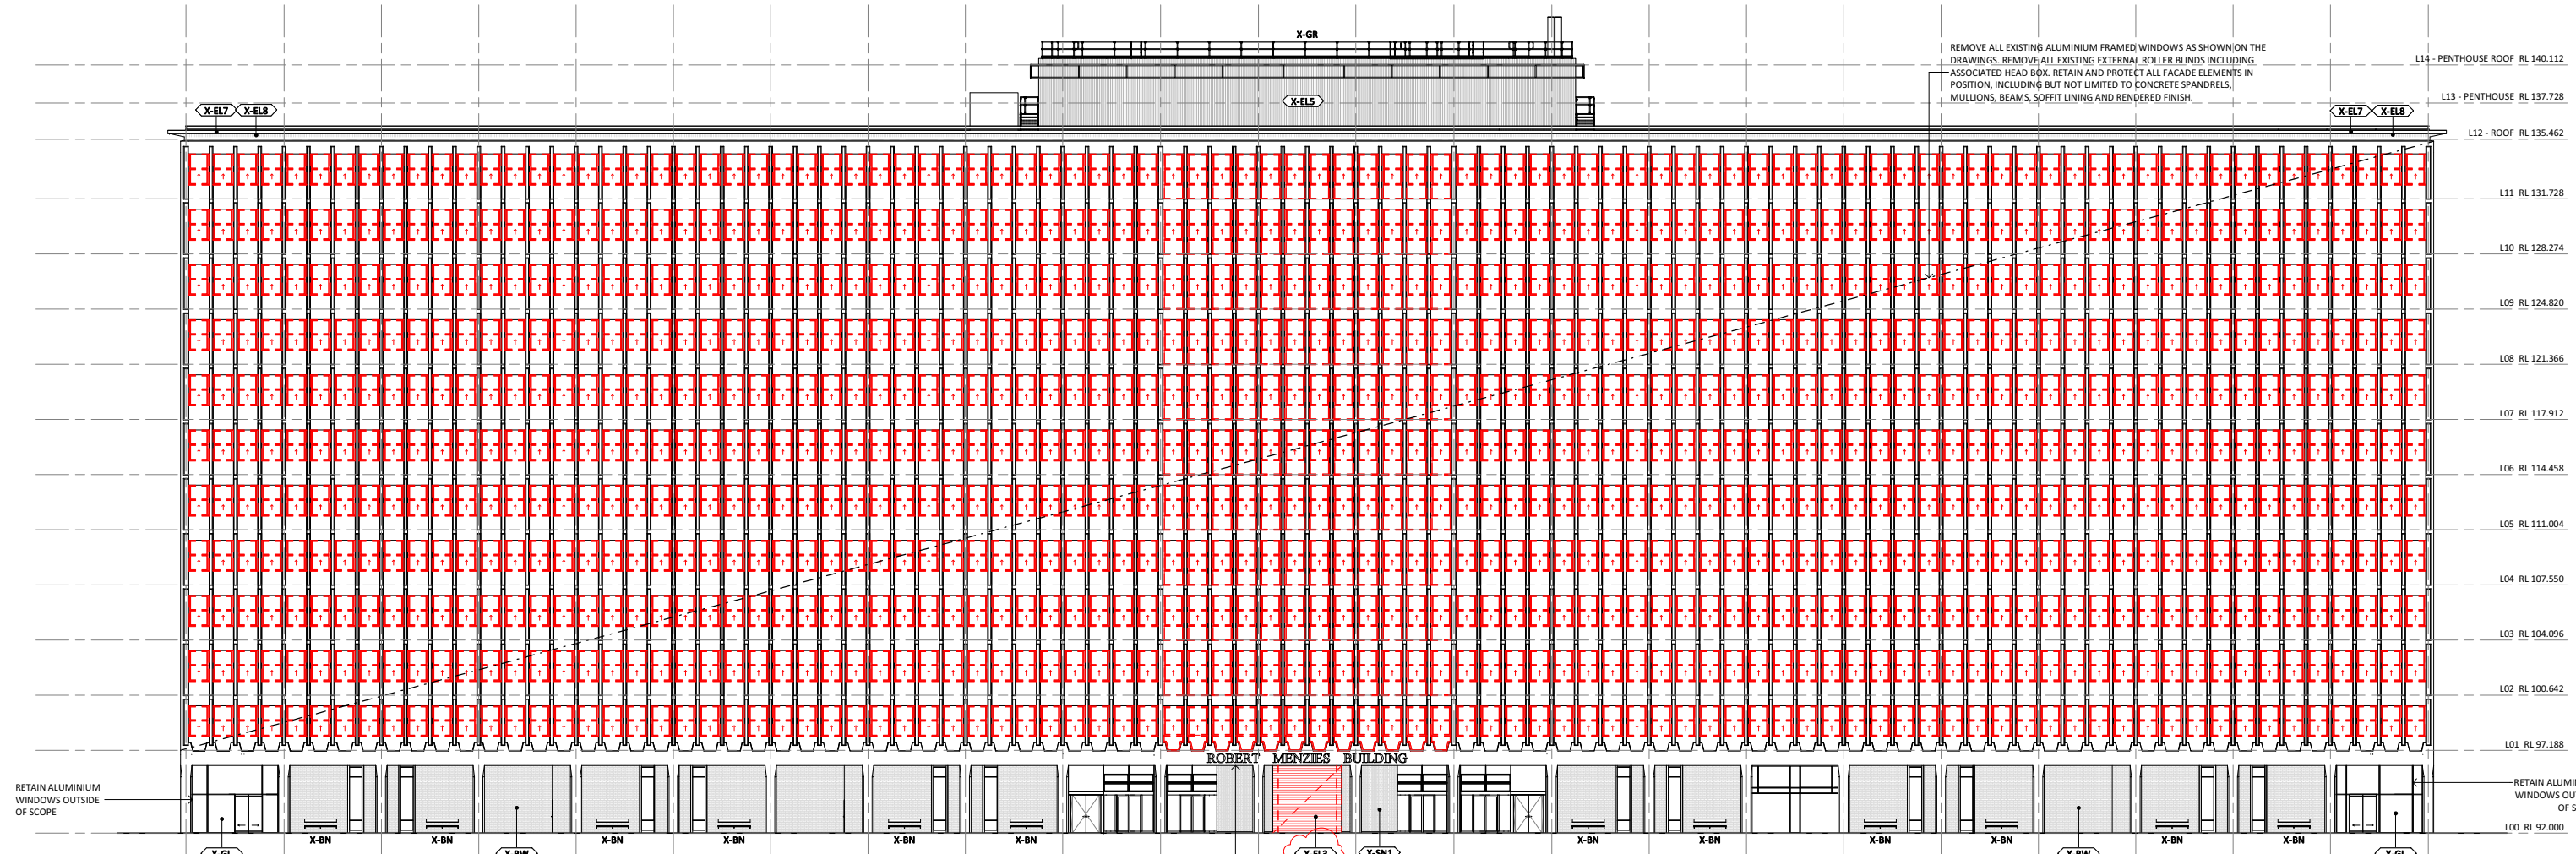

01 ELEVATION - NORTH - DEMOLITION
SCALE 1 : 200

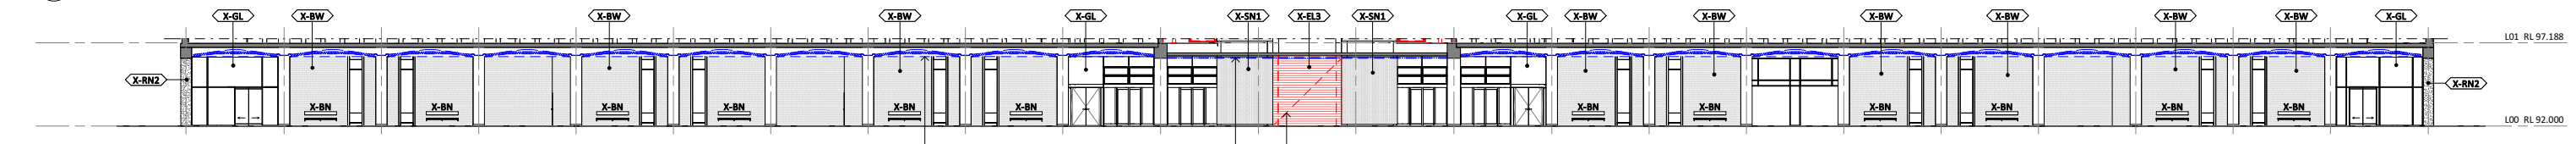

02 ELEVATION - NORTH COLONNADE - DEMOLITION
SCALE 1 : 200

RETAIN AND PROTECT ALL CONCRETE BEAMS AND COLUMNS TO COLONNADE.

RETAIN AND PROTECT ALL CONCRETE BEAMS AND COLUMNS TO COLONNADE.

TEMPORARILY REMOVE TIMBER SLAT CEILING TO SOFFIT OF COLONNADE. REFER REFLECTED CEILING PLAN FOR DETAILS.

REMOVE COMBUSTIBLE TIMBER CLADDING TO NON-ORIGINAL LIFT SHAFT. REMOVE ALL ASSOCIATED FRAMING, SARKING, FLASHINGS, WEATHER SEALS.

EXTERNAL FINISHES LEGEND:

- X-BW EXISTING BRICKWORK
- M-P23a EXTERIOR PAINT FINISH - FACADE COLUMNS
- M-P23b EXTERIOR PAINT FINISH - FACADE SPANDRELS
- X-RN1 EXISTING RENDER - PAINT FINISH
- X-RN2 EXISTING RENDER - PAINT FINISH
- X-GL EXISTING GLAZING
- X-EL3 EXISTING TIMBER CLADDING
- X-EL4 EXISTING CLADDING TO MOSAIC TILES
- X-EL5 EXISTING CORRUGATED WALL CLADDING
- X-EL6 EXISTING ALUMINIUM WALL CLADDING
- X-CO1 EXISTING PRECAST PANEL
- X-EL7 EXISTING FIBRE GLASS FASCIA LINING
- X-EL8 EXISTING RIPPLE IRON SOFFIT LINING
- X-AM1 EXISTING METAL CAPPING
- X-SN1 ORIGINAL STONE CLADDING
- X-AM2 EXISTING ALUMINIUM LOUVRE
- X-AM3 EXISTING METAL SCREEN
- X-RS1 EXISTING ROOF SHEETING - TYPE 1
- X-RS2 EXISTING ROOF SHEETING - TYPE 2
- X-RS3 EXISTING ROOF SHEETING - TYPE 3
- X-EL1 EXISTING METAL WALL CLADDING
- X-EL2 EXISTING METAL WALL CLADDING
- M-P24a EXTERIOR PAINT FINISH - EXISTING METAL WALL CLADDING
- X-CO2 EXTERIOR PAINT FINISH - EXISTING BLOCKWORK WALL
- X-CL1 ORIGINAL TIMBER SLAT CEILING

EXTENT OF WORKS LEGEND:

- EXISTING FABRIC RETAINED
- EXISTING FABRIC TO BE DEMOLISHED
- EXISTING FABRIC TO BE TEMPORARILY REMOVED, STORED SAFELY AND REINSTATED AS PART OF THE WORKS

FACADES LEGEND:

- X-BN EXISTING BENCHES
- X-GR EXISTING GUARDRAILS
- X-ME EXISTING MECHANICAL EQUIPMENT

GENERAL NOTES:

1. ALL DRAWINGS ARE TO BE READ IN CONJUNCTION WITH THE ARCHITECTURAL SPECIFICATIONS.
2. ALL DRAWINGS ARE TO BE READ IN CONJUNCTION WITH ALL CONSULTANT DOCUMENTATION.
3. DRAWINGS OF A LARGER SCALE TAKE PRECEDENCE OVER DRAWINGS AT A SMALLER SCALE.
4. ALL EXISTING STRUCTURAL MEMBERS AND FACADE CONSTRUCTION ARE INDICATIVE ONLY. CONTRACTOR IS TO CONFIRM ON SITE EXISTING CONDITION, LEVELS, SIZES AND FIRE RATING TREATMENT.
5. DO NOT SCALE OFF DRAWINGS. USE DIMENSIONS ONLY.
6. ALL DIMENSIONS ARE NOMINAL ONLY. CONTRACTOR TO CONFIRM ALL BUILT AND PROPOSED DIMENSIONS ON SITE PRIOR TO MANUFACTURE OR PREPARING SHOP DRAWINGS.
7. CONTRACTOR IS TO CHECK AND CONFIRM EXISTING CONDITIONS ON SITE. LEVELS, ALIGNMENTS, EXISTING RETAINED STRUCTURE AND ALL OTHER NECESSARY INFORMATION, PRIOR TO COMMENCING ANY WORKS. NOTIFY THE SUPERINTENDENT OF ANY OMISSIONS OR DISCREPANCIES AND SEEK WRITTEN ADVICE PRIOR TO PROCEEDING.

DEMOLITION WORKS NOTES:

1. ALL DEMOLITION WORK TO BE CARRIED OUT IN ACCORDANCE WITH AND TO COMPLY WITH AS2601.
2. FOLLOWING DEMOLITION ALL RUBBLE, DEBRIS AND DUST ARE TO BE REMOVED AND DISPOSED OFF SITE IN ACCORDANCE WITH ALL RELEVANT AUTHORITIES REQUIREMENTS AND GUIDELINES.
3. CONTRACTOR IS TO MAKE GOOD ANY DAMAGE CAUSED DUE TO DEMOLITION WORKS. LAISE WITH SUPERINTENDENT FOR REMEDIATION WORKS.
4. REMOVE EXISTING ALUMINIUM FRAMED WINDOWS AS SHOWN ON THE DRAWINGS. WHERE EXISTING WINDOWS ARE SCORED FOR REMOVAL, REMOVE THE ENTIRE WINDOW AND ALL ASSOCIATED COMPONENTS INCLUDING BUT NOT LIMITED TO FLASHINGS, TAPES, SEALANTS, BRACKETS.
5. RETAIN AND PROTECT ALL FACADE ELEMENTS IN POSITION, INCLUDING BUT NOT LIMITED TO CONCRETE SPANDRELS, MULLIONS, BEAMS, SOFFIT LINING AND RENDERED FINISH.
6. REMOVE ALL EXISTING EXTERNAL ROLLER BLINDS INCLUDING ASSOCIATED HEAD BOX, FLASHINGS AND BRACKETS.
7. REMOVE ALL MECHANICAL LOUVERS AND ADJACENT TRIMS AND FIXINGS.
8. REMOVE ALL REDUNDANT SERVICES.
9. ALLOW TO REMOVE ALL ASBESTOS AND DAMAGED SEALANTS.

PROTECTION NOTES:

1. CONTRACTOR TO PREPARE DILAPIDATION REPORT OF EXISTING CONDITIONS FOR SUPERINTENDENT'S APPROVAL PRIOR TO COMMENCEMENT OF WORKS.
2. PROTECT EXISTING FABRIC TO BE RETAINED FROM DAMAGE DURING DEMOLITION WORKS INCLUDING, BUT NOT LIMITED TO DOORS, GLAZED CURTAIN WALLS AND WINDOWS, WALLS, FLOORS, CEILINGS, STAIRS, ROOFING, SAFE ROOF ACCESS SYSTEM, CLADDING SYSTEMS, SERVICES, FITTINGS AND FIXTURES, FRAMING OR STRUCTURAL ELEMENTS.
3. CONTRACTOR TO CONFIRM, RETAIN AND PROTECT ALL EXISTING FIRE RATED TREATMENTS, INCLUDING SPRINKLER SYSTEM, INTERNAL AND EXTERNAL LININGS, CLADDINGS AND FIRE RATED COATINGS TO STRUCTURAL ELEMENTS, UNLESS NOTED OTHERWISE.
4. WHERE INTERNAL OR EXTERNAL ELEMENTS ARE REQUIRED TO BE REMOVED TO ENABLE THE WORKS, THESE ARE TO BE STORED AND REINSTATED TO MATCH THE EXISTING CONDITION.
5. CONTRACTOR TO REPAIR ANY DAMAGE TO RETAINED FABRIC TO MATCH EXISTING CONDITION, TO THE SUPERINTENDENT'S APPROVAL.
6. MAINTAIN THE EXISTING BUILDING IN A SECURE AND WATER TIGHT CONDITION AT ALL TIMES THROUGHOUT THE WORKS
7. PROTECT THE SITE AT ALL TIMES FROM UNAUTHORISED ACCESS
8. PROTECT ALL LANDSCAPE LOCATED IN SITE COMPOUND

FILE: BIM 360//MONASH Menzies/AR_LC_0104_Menzies Building_Rev42021.rvt
 PRINTED: 25/11/2021 11:56:09 AM
 A1 594 x 841

ACOUSTIC ENGINEERING
Cundall
 L2/330 Little Collins Street
 Melbourne, VIC 3000
 T (03) 9635 3700
 cundall.com

BUILDING SURVEYOR
Steve Watson & Partners
 Level 6 / 350 Queen Street
 Melbourne, VIC 3000
 T (03) 9380 5558
 swpartners.com.au

BUILDING SERVICES ENGINEER + ESD
WSP
 Level 15/28 Freshwater Place
 Southbank, Vic 3006
 T (03) 9961 1111
 wsp.com

CIVIL, FACADE & STRUCTURE ENGINEERING
WSP
 Level 15/28 Freshwater Place
 Southbank, Vic 3006
 T (03) 9961 1111
 wsp.com

DDA CONSULTANT
Architecture & Access
 Level 5 / 369 Royal Parade
 Parkville, VIC 3052
 T 1300 715 866
 architectureandaccess.com.au

REV.	DETAILS	DATE
3	TOWN PLANNING	25/11/2021
2	TOWN PLANNING	22/09/2021
1	SCHEMATIC DESIGN	30/08/2021



PROJECT
MONASH MENZIES REDEVELOPMENT - STAGE 2
 MONASH UNIVERSITY CLAYTON CAMPUS

DRAWING TITLE
ELEVATIONS - NORTH - DEMOLITION

NORTH


FOR APPROVAL
 TOWN PLANNING

SCALE
1:200@A1

JOB No. DRAWN CHECKED DATE
 MM08 VK MT SEPT 2021

DRAWING No. REVISION
 CL_11_A_6010 **3**

ALL DIMENSIONS ARE IN MILLIMETERS. DO NOT SCALE DRAWINGS FOR CRITICAL DIMENSIONS. CHECK DRAWING IS TO SCALE BY MEASURING SCALE BAR BELOW. VERIFY ALL DIMENSIONS ON SITE BEFORE COMMENCING ANY WORK, SHOP DRAWINGS OR ORDERING MATERIALS.

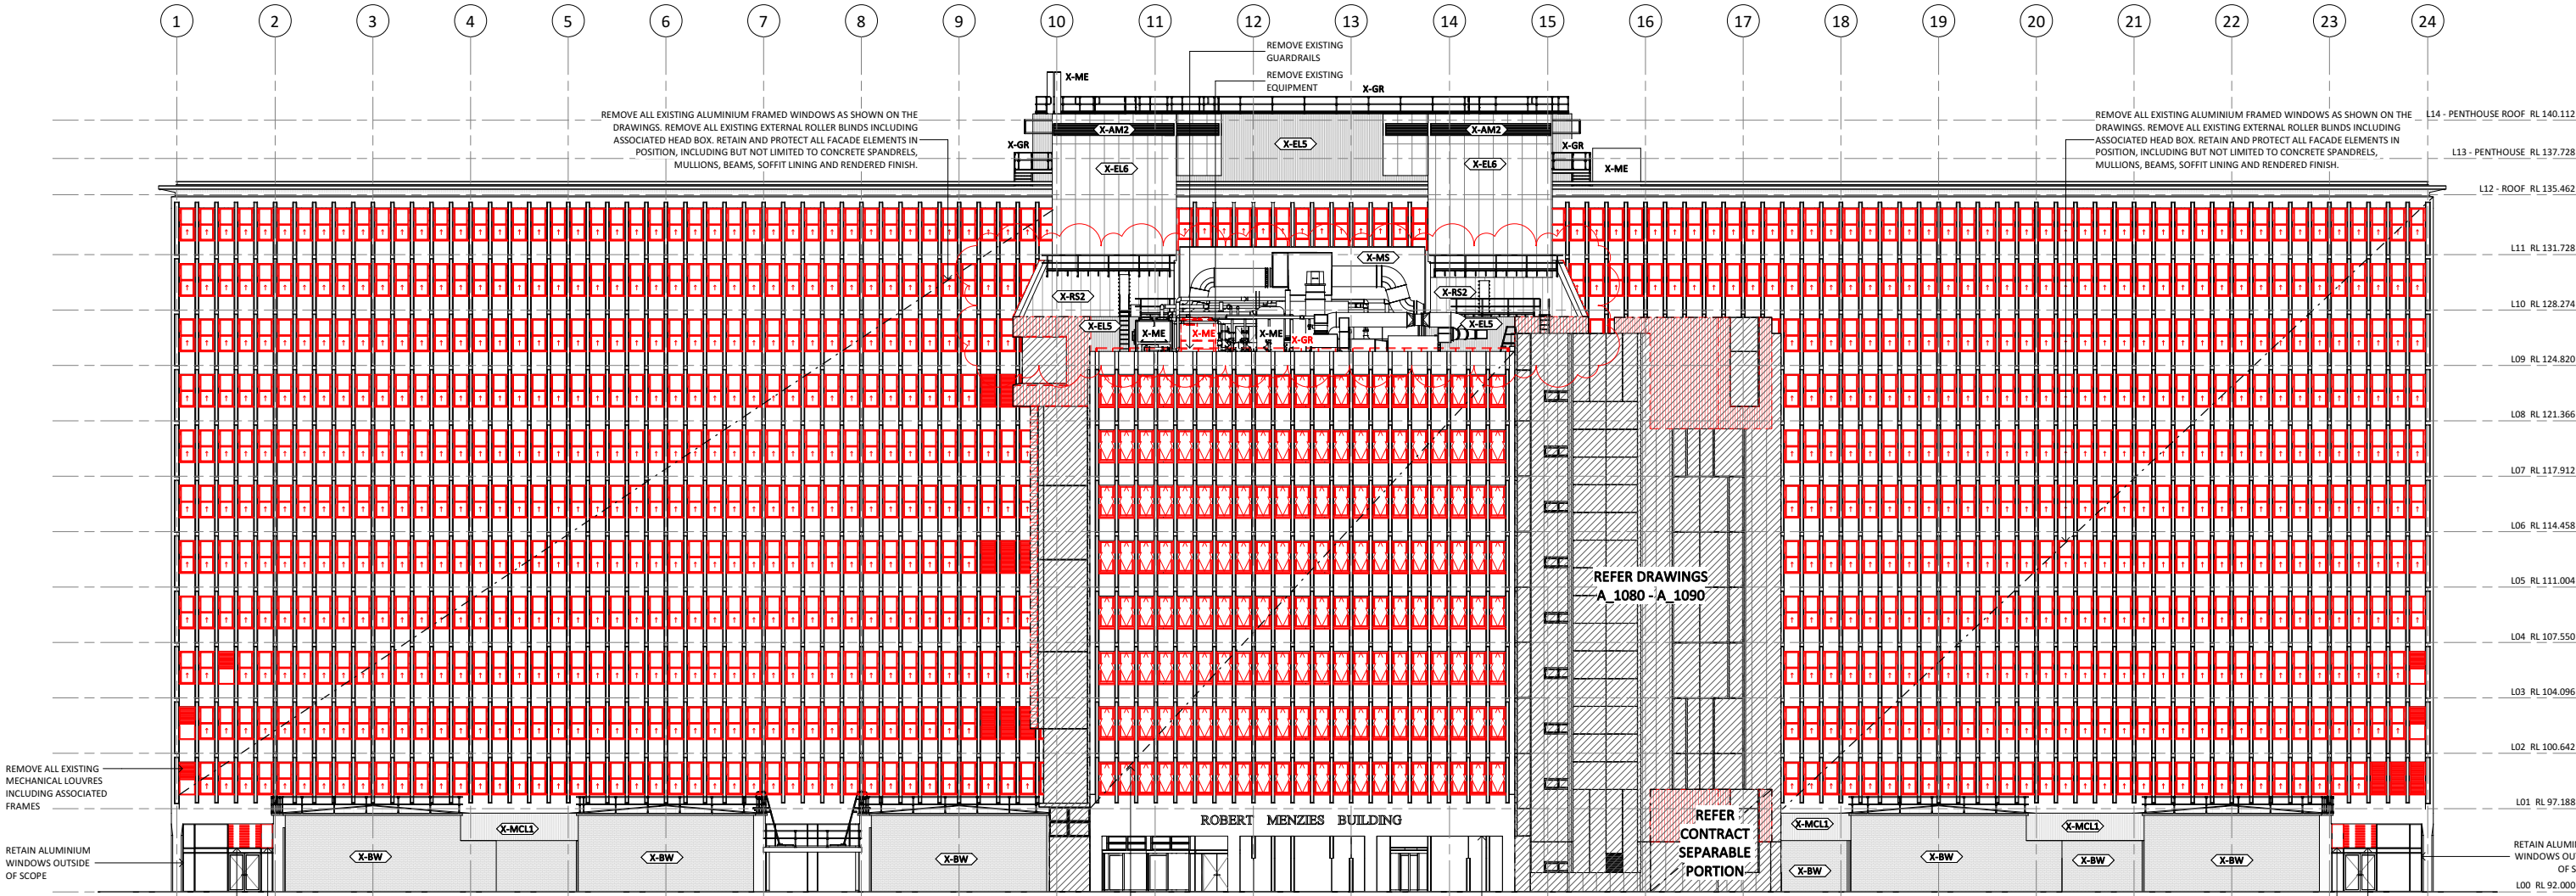

01 ELEVATION - SOUTH - DEMOLITION
SCALE 1 : 200

EXTENT OF WORKS LEGEND:


- EXISTING FABRIC RETAINED
- EXISTING FABRIC TO BE DEMOLISHED
- EXISTING FABRIC TO BE TEMPORARILY REMOVED, STORED SAFELY AND REINSTATED AS PART OF THE WORKS

EXTERNAL FINISHES LEGEND:

- X-BW EXISTING BRICKWORK
- M-P23a EXTERIOR PAINT FINISH - FACADE COLUMNS
- M-P23b EXTERIOR PAINT FINISH - FACADE SPANDRELS
- X-RN1 EXISTING RENDER - PAINT FINISH
- X-RN2 EXISTING RENDER - PAINT FINISH
- X-GL EXISTING GLAZING
- X-EL3 EXISTING TIMBER CLADDING
- X-EL4 EXISTING CLADDING TO MOSAIC TILES
- X-EL5 EXISTING CORRUGATED WALL CLADDING
- X-EL6 EXISTING ALUMINIUM WALL CLADDING
- X-CON1 EXISTING PRECAST PANEL
- X-EL7 EXISTING FIBRE GLASS FASCIA LINING
- X-EL8 EXISTING RIPPLE IRON SOFFIT LINING
- X-AM1 EXISTING METAL CAPPING
- X-SN1 ORIGINAL STONE CLADDING
- X-AM2 EXISTING ALUMINIUM LOUVRE
- X-AM3 EXISTING METAL SCREEN
- X-RS1 EXISTING ROOF SHEETING - TYPE 1
- X-RS2 EXISTING ROOF SHEETING - TYPE 2
- X-RS3 EXISTING ROOF SHEETING - TYPE 3
- X-EL1 EXISTING METAL WALL CLADDING
- X-EL2 EXISTING METAL WALL CLADDING
- M-P24a EXTERIOR PAINT FINISH - EXISTING METAL WALL CLADDING
- X-CON2 EXTERIOR PAINT FINISH - EXISTING BLOCKWORK WALL
- X-CL1 ORIGINAL TIMBER SLAT CEILING

FACADES LEGEND:

- X-BN EXISTING BENCHES
- X-GR EXISTING GUARDRAILS
- X-ME EXISTING MECHANICAL EQUIPMENT

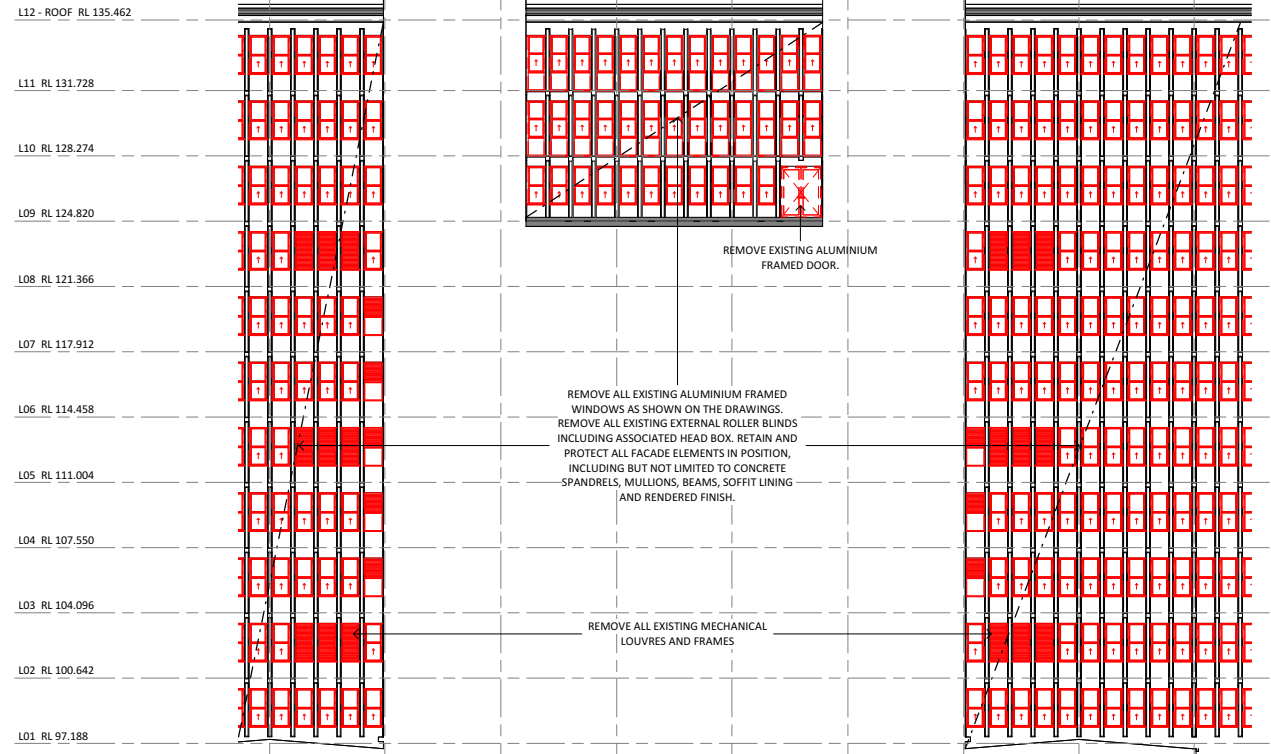

02 ELEVATION - SOUTH - BEYOND LIFT TOWER - DEMOLITION
SCALE 1 : 200

GENERAL NOTES:

1. ALL DRAWINGS ARE TO BE READ IN CONJUNCTION WITH THE ARCHITECTURAL SPECIFICATIONS.
2. ALL DRAWINGS ARE TO BE READ IN CONJUNCTION WITH ALL CONSULTANT DOCUMENTATION.
3. DRAWINGS OF A LARGER SCALE TAKE PRECEDENCE OVER DRAWINGS AT A SMALLER SCALE.
4. ALL EXISTING STRUCTURAL MEMBERS AND FACADE CONSTRUCTION ARE INDICATIVE ONLY. CONTRACTOR IS TO CONFIRM ON SITE EXISTING CONDITION, LEVELS, SIZES AND FIRE RATING TREATMENT.
5. DO NOT SCALE OFF DRAWINGS, USE DIMENSIONS ONLY.
6. ALL DIMENSIONS ARE NOMINAL ONLY. CONTRACTOR TO CONFIRM ALL BUILT AND PROPOSED DIMENSIONS ON SITE PRIOR TO MANUFACTURE OR PREPARING SHOP DRAWINGS.
7. CONTRACTOR IS TO CHECK AND CONFIRM EXISTING CONDITIONS ON SITE, LEVELS, ALIGNMENTS, EXISTING RETAINED STRUCTURE AND ALL OTHER NECESSARY INFORMATION, PRIOR TO COMMENCING ANY WORKS. NOTIFY THE SUPERINTENDENT OF ANY OMISSIONS OR DISCREPANCIES AND SEEK WRITTEN ADVICE PRIOR TO PROCEEDING.

DEMOLITION WORKS NOTES:

1. ALL DEMOLITION WORK TO BE CARRIED OUT IN ACCORDANCE WITH AND TO COMPLY WITH AS2601.
2. FOLLOWING DEMOLITION ALL RUBBLE, DEBRIS AND DUST ARE TO BE REMOVED AND DISPOSED OFF SITE IN ACCORDANCE WITH ALL RELEVANT AUTHORITIES REQUIREMENTS AND GUIDELINES.
3. CONTRACTOR IS TO MAKE GOOD ANY DAMAGE CAUSED DUE TO DEMOLITION WORKS, LIAISE WITH SUPERINTENDENT FOR REMEDIATION WORKS.
4. REMOVE EXISTING ALUMINIUM FRAMED WINDOWS AS SHOWN ON THE DRAWINGS, WHERE EXISTING WINDOWS ARE SCOPED FOR REMOVAL, REMOVE THE ENTIRE WINDOW AND ALL ASSOCIATED COMPONENTS INCLUDING BUT NOT LIMITED TO FLASHINGS, TAPES, SEALANTS, BRACKETS.
5. RETAIN AND PROTECT ALL FACADE ELEMENTS IN POSITION, INCLUDING BUT NOT LIMITED TO CONCRETE SPANDRELS, MULLIONS, BEAMS, SOFFIT LINING AND RENDERED FINISH.
6. REMOVE ALL EXISTING EXTERNAL ROLLER BLINDS INCLUDING ASSOCIATED HEAD BOX, FLASHINGS AND BRACKETS.
7. REMOVE ALL MECHANICAL LOUVRES AND ADJACENT TRIMS AND FIXINGS.
8. REMOVE ALL REDUNDANT SERVICES.
9. REMOVE ALL REDUNDANT ACCESS SYSTEM COMPONENTS.
10. ALLOW TO REMOVE ALL ASBESTOS AND DAMAGED SEALANTS.

PROTECTION NOTES:

1. CONTRACTOR TO PREPARE DILAPIDATION REPORT OF EXISTING CONDITIONS FOR SUPERINTENDENT'S APPROVAL PRIOR TO COMMENCEMENT OF WORKS.
2. PROTECT EXISTING FABRIC TO BE RETAINED FROM DAMAGE DURING DEMOLITION WORKS INCLUDING, BUT NOT LIMITED TO DOORS, GLAZED CURTAIN WALLS AND WINDOWS, WALLS, FLOORS, CEILINGS, STAIRS, ROOFING, SAFE ROOF ACCESS SYSTEM, CLADDING SYSTEMS, SERVICES, FITTINGS AND FIXTURES, FRAMING OR STRUCTURAL ELEMENTS.
3. CONTRACTOR TO CONFIRM, RETAIN AND PROTECT ALL EXISTING FIRE RATED TREATMENTS, INCLUDING SPRINKLER SYSTEM, INTERNAL AND EXTERNAL LININGS, CLADDINGS AND FIRE RATED COATINGS TO FACADE ELEMENTS, UNLESS NOTED OTHERWISE.
4. WHERE INTERNAL OR EXTERNAL ELEMENTS ARE REQUIRED TO BE REMOVED TO ENABLE THE WORKS, THESE ARE TO BE STORED AND REINSTATED TO MATCH THE EXISTING CONDITION.
5. CONTRACTOR TO REPAIR ANY DAMAGE TO RETAINED FABRIC TO MATCH EXISTING CONDITION, TO THE SUPERINTENDENT'S APPROVAL.
6. MAINTAIN THE EXISTING BUILDING IN A SECURE AND WATER TIGHT CONDITION AT ALL TIMES THROUGHOUT THE WORKS.
7. PROTECT THE SITE AT ALL TIMES FROM UNAUTHORISED ACCESS.
8. PROTECT ALL LANDSCAPE LOCATED IN SITE COMPOUND.

ACOUSTIC ENGINEERING
Cundall
L2/330 Little Collins Street
Melbourne, VIC 3000
T (03) 9638 3700
cundall.com

BUILDING SURVEYOR
Steve Watson & Partners
Level 6/ 350 Queen Street
Melbourne, VIC 3000
T (03) 9380 5558
swpartners.com.au

BUILDING SERVICES ENGINEER + ESD
WSP
Level 15/28 Freshwater Place
Southbank, Vic 3006
T (03) 9661 1111
wsp.com

CIVIL, FACADE & STRUCTURE ENGINEERING
WSP
Level 15/28 Freshwater Place
Southbank, Vic 3006
T (03) 9661 1111
wsp.com

DDA CONSULTANT
Architecture & Access
Level 5/ 369 Royal Parade
Parkville, VIC 3052
T 1300 715 866
architectureandaccess.com.au

REV.	DETAILS	DATE
3	TOWN PLANNING	25/11/2021
2	TOWN PLANNING	22/09/2021
1	SCHEMATIC DESIGN	30/08/2021



PROJECT
MONASH MENZIES REDEVELOPMENT - STAGE 2
MONASH UNIVERSITY CLAYTON CAMPUS

DRAWING TITLE
ELEVATIONS - SOUTH - DEMOLITION

NORTH




FOR APPROVAL
TOWN PLANNING

SCALE
1:200@A1

JOB No. DRAWN CHECKED DATE
MM08 VK MT SEPT 2021

DRAWING No. REVISION
CL_11_A_6011 3

ALL DIMENSIONS ARE IN MILLIMETERS. DO NOT SCALE DRAWINGS FOR CRITICAL DIMENSIONS. CHECK DRAWING IS TO SCALE BY MEASURING SCALE BAR BELOW. VERIFY ALL DIMENSIONS ON SITE BEFORE COMMENCING ANY WORK, SHOP DRAWINGS OR ORDERING MATERIALS.

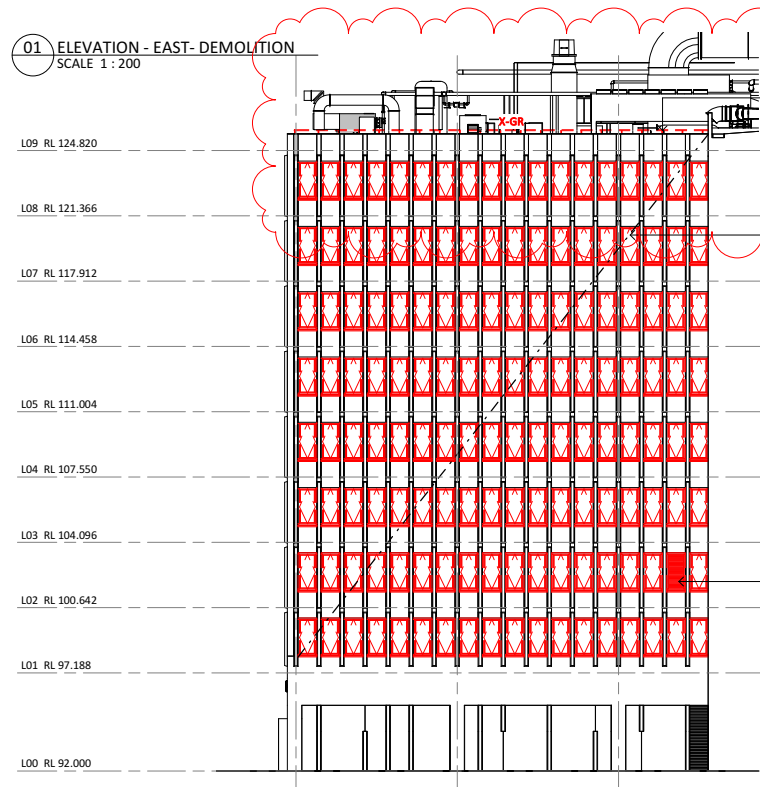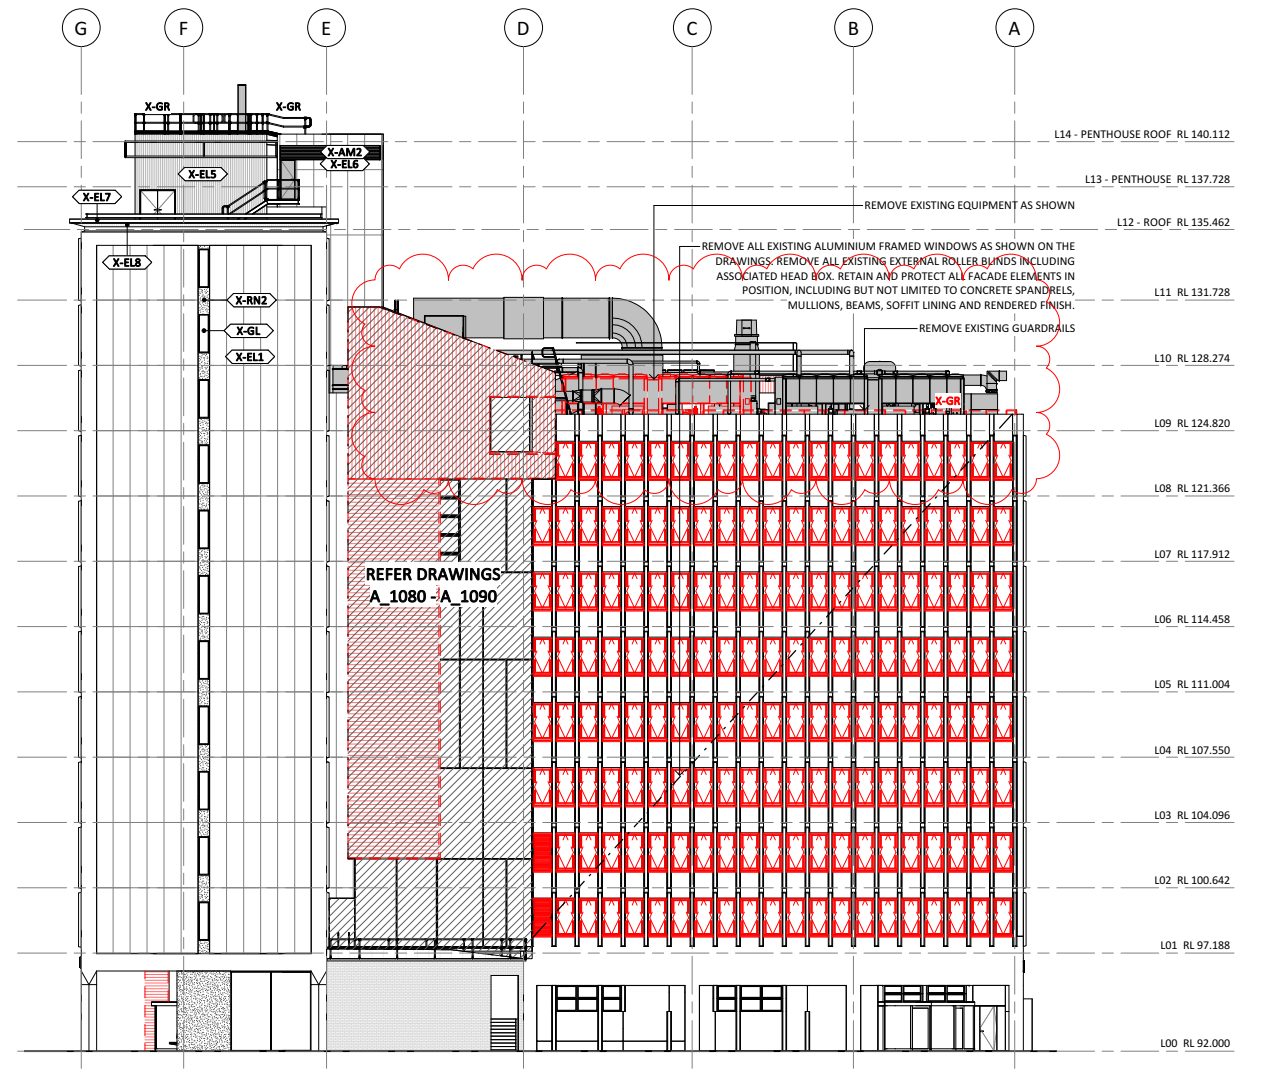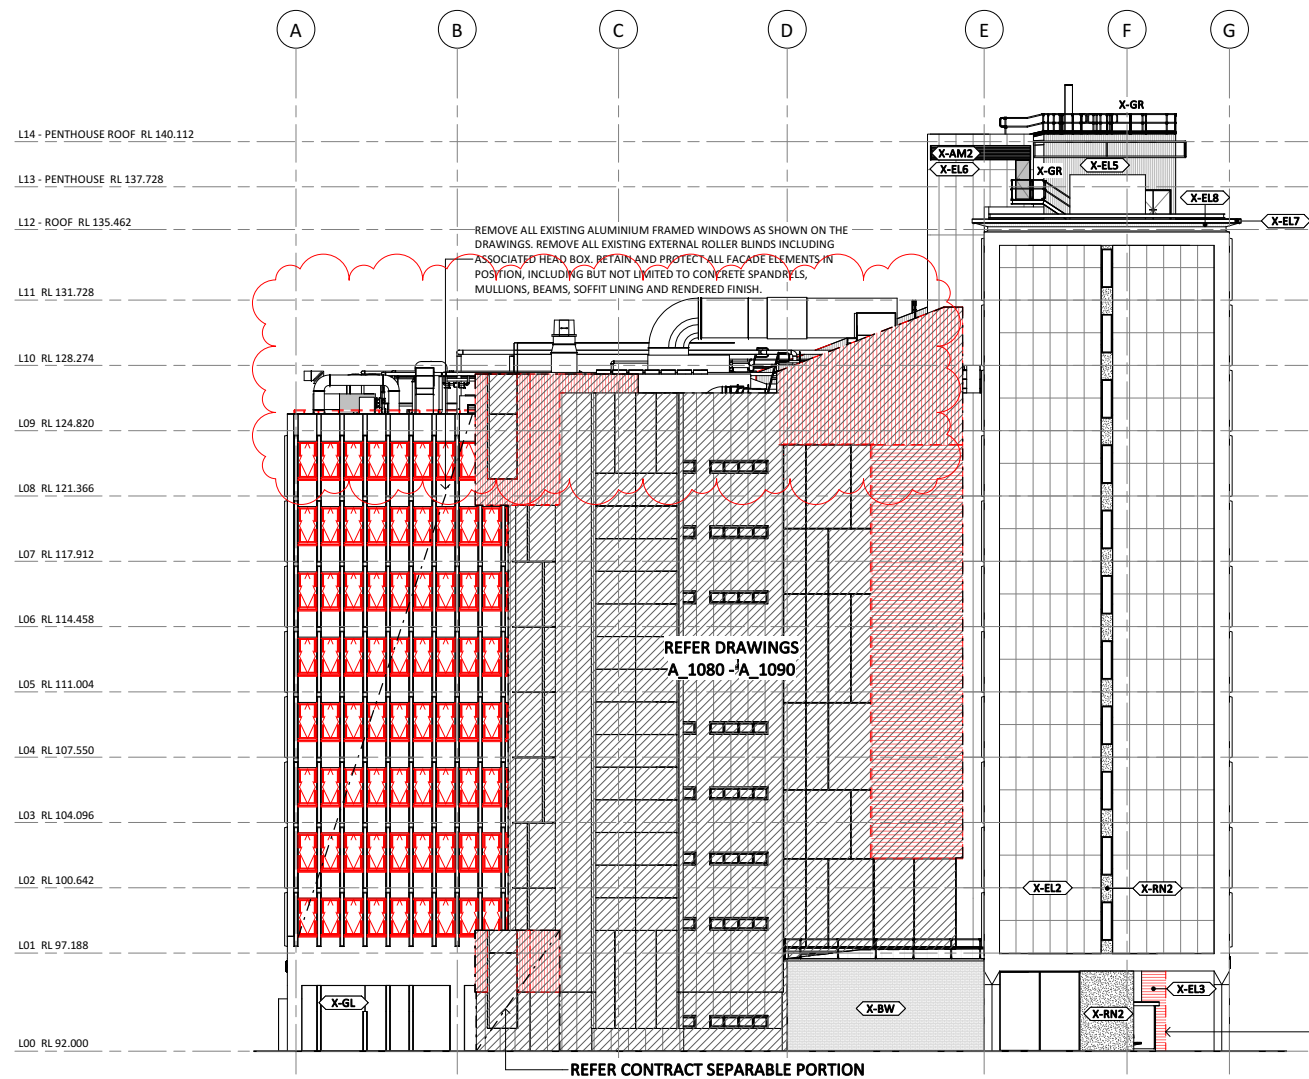

02 ELEVATION - EAST - BEYOND LIFT TOWER - DEMOLITION
SCALE 1 : 200

03 ELEVATION - WEST - DEMOLITION
SCALE 1 : 200

EXTENT OF WORKS LEGEND:

- EXISTING FABRIC RETAINED
- EXISTING FABRIC TO BE DEMOLISHED
- EXISTING FABRIC TO BE TEMPORARILY REMOVED, STORED SAFELY AND REINSTATED AS PART OF THE WORKS

EXTERNAL FINISHES LEGEND:

- X-BW** EXISTING BRICKWORK
- M-P23a** EXTERIOR PAINT FINISH - FACADE COLUMNS
- M-P23b** EXTERIOR PAINT FINISH - FACADE SPANDRELS
- X-RN1** EXISTING RENDER - PAINT FINISH
- X-RN2** EXISTING RENDER - PAINT FINISH
- X-GL** EXISTING GLAZING
- X-EL3** EXISTING TIMBER CLADDING
- X-EL4** EXISTING CLADDING TO MOSAIC TILES
- X-EL5** EXISTING CORRUGATED WALL CLADDING
- X-EL6** EXISTING ALUMINIUM WALL CLADDING
- X-CON1** EXISTING PRECAST PANEL
- X-EL7** EXISTING FIBRE GLASS FASCIA LINING
- X-EL8** EXISTING RIPPLE IRON SOFFIT LINING
- X-AM1** EXISTING METAL CAPPING
- X-SN1** ORIGINAL STONE CLADDING
- X-AM2** EXISTING ALUMINIUM LOUVRE
- X-AM3** EXISTING METAL SCREEN
- X-RS1** EXISTING ROOF SHEETING - TYPE 1
- X-RS2** EXISTING ROOF SHEETING - TYPE 2
- X-RS3** EXISTING ROOF SHEETING - TYPE 3
- X-EL1** EXISTING METAL WALL CLADDING
- X-EL2** EXISTING METAL WALL CLADDING
- M-P24a** EXTERIOR PAINT FINISH - EXISTING METAL WALL CLADDING
- X-CON2** EXTERIOR PAINT FINISH - EXISTING BLOCKWORK WALL
- X-CL1** ORIGINAL TIMBER SLAT CEILING

FACADES LEGEND:

- X-BN** EXISTING BENCHES
- X-GR** EXISTING GUARDRAILS
- X-ME** EXISTING MECHANICAL EQUIPMENT

GENERAL NOTES:

1. ALL DRAWINGS ARE TO BE READ IN CONJUNCTION WITH THE ARCHITECTURAL SPECIFICATIONS.
2. ALL DRAWINGS ARE TO BE READ IN CONJUNCTION WITH ALL CONSULTANT DOCUMENTATION.
3. DRAWINGS OF A LARGER SCALE TAKE PRECEDENCE OVER DRAWINGS AT A SMALLER SCALE.
4. ALL EXISTING STRUCTURAL MEMBERS AND FACADE CONSTRUCTION ARE INDICATIVE ONLY. CONTRACTOR IS TO CONFIRM ON SITE EXISTING CONDITION, LEVELS, SIZES AND FIRE RATING TREATMENT.
5. DO NOT SCALE OFF DRAWINGS, USE DIMENSIONS ONLY.
6. ALL DIMENSIONS ARE NOMINAL ONLY. CONTRACTOR TO CONFIRM ALL BUILT AND PROPOSED DIMENSIONS ON SITE PRIOR TO MANUFACTURE OR PREPARING SHOP DRAWINGS.
7. CONTRACTOR IS TO CHECK AND CONFIRM EXISTING CONDITIONS ON SITE, LEVELS, ALIGNMENTS, EXISTING RETAINED STRUCTURE AND ALL OTHER NECESSARY INFORMATION, PRIOR TO COMMENCING ANY WORKS. NOTIFY THE SUPERINTENDENT OF ANY OMISSIONS OR DISCREPANCIES AND SEEK WRITTEN ADVICE PRIOR TO PROCEEDING.

DEMOLITION WORKS NOTES:

1. ALL DEMOLITION WORK TO BE CARRIED OUT IN ACCORDANCE WITH AND TO COMPLY WITH AS2601.
2. FOLLOWING DEMOLITION ALL RUBBLE, DEBRIS AND DUST ARE TO BE REMOVED AND DISPOSED OFF SITE IN ACCORDANCE WITH ALL RELEVANT AUTHORITIES REQUIREMENTS AND GUIDELINES.
3. CONTRACTOR IS TO MAKE GOOD ANY DAMAGE CAUSED DUE TO DEMOLITION WORKS. LIAISE WITH SUPERINTENDENT FOR REMEDIATION WORKS.
4. REMOVE EXISTING ALUMINIUM FRAMED WINDOWS AS SHOWN ON THE DRAWINGS. WHERE EXISTING WINDOWS ARE SCOPED FOR REMOVAL, REMOVE THE ENTIRE WINDOW AND ALL ASSOCIATED COMPONENTS INCLUDING BUT NOT LIMITED TO FLASHINGS, TAPES, SEALANTS, BRACKETS.
5. RETAIN AND PROTECT ALL FACADE ELEMENTS IN POSITION, INCLUDING BUT NOT LIMITED TO CONCRETE SPANDRELS, MULLIONS, BEAMS, SOFFIT LINING AND RENDERED FINISH.
6. REMOVE ALL EXISTING EXTERNAL ROLLER BLINDS INCLUDING ASSOCIATED HEAD BOX, FLASHINGS AND BRACKETS.
7. REMOVE ALL MECHANICAL LOUVRES AND ADJACENT TRIMS AND FIXINGS.
8. REMOVE ALL REDUNDANT SERVICES.
9. ALLOW TO REMOVE ALL ASBESTOS AND DAMAGED SEALANTS.

PROTECTION NOTES:

1. CONTRACTOR TO PREPARE DILAPIDATION REPORT OF EXISTING CONDITIONS FOR SUPERINTENDENT'S APPROVAL PRIOR TO COMMENCEMENT OF WORKS.
2. PROTECT EXISTING FABRIC TO BE RETAINED FROM DAMAGE DURING DEMOLITION WORKS INCLUDING, BUT NOT LIMITED TO DOORS, GLAZED CURTAIN WALLS AND WINDOWS, WALLS, FLOORS, CEILINGS, STAIRS, ROOFING, SAFE ROOF ACCESS SYSTEM, CLADDING SYSTEMS, SERVICES, FITTINGS AND FIXTURES, FRAMING OR STRUCTURAL ELEMENTS.
3. CONTRACTOR TO CONFIRM, RETAIN AND PROTECT ALL EXISTING FIRE RATED TREATMENTS, INCLUDING SPRINKLER SYSTEM, INTERNAL AND EXTERNAL LININGS, CLADDINGS AND FIRE RATED COATINGS TO STRUCTURAL ELEMENTS.
4. WHERE INTERNAL OR EXTERNAL ELEMENTS ARE REQUIRED TO BE REMOVED TO ENABLE THE WORKS, THESE ARE TO BE STORED AND REINSTATED TO MATCH THE EXISTING CONDITION.
5. CONTRACTOR TO REPAIR ANY DAMAGE TO RETAINED FABRIC TO MATCH EXISTING CONDITION, TO THE SUPERINTENDENT'S APPROVAL.
6. MAINTAIN THE EXISTING BUILDING IN A SECURE AND WATER TIGHT CONDITION AT ALL TIMES THROUGHOUT THE WORKS.
7. PROTECT THE SITE AT ALL TIMES FROM UNAUTHORISED ACCESS.
8. PROTECT ALL LANDSCAPE LOCATED IN SITE COMPOUND.

ACOUSTIC ENGINEERING
Cundall
L2/330 Little Collins Street
Melbourne, VIC 3000
T (03) 9635 3700
cundall.com

BUILDING SURVEYOR
Steve Watson & Partners
Level 6/ 350 Queen Street
Melbourne, VIC 3000
T (03) 9380 5558
swpartners.com.au

BUILDING SERVICES ENGINEER + ESD
WSP
Level 15/28 Freshwater Place
Southbank, Vic 3006
T (03) 9661 1111
wsp.com

CIVIL, FACADE & STRUCTURE ENGINEERING
WSP
Level 15/28 Freshwater Place
Southbank, Vic 3006
T (03) 9661 1111
wsp.com

DDA CONSULTANT
Architecture & Access
Level 5/ 369 Royal Parade
Parkville, VIC 3052
T 1300 715 866
architectureandaccess.com.au

REV.	DETAILS	DATE
3	TOWN PLANNING	25/11/2021
2	TOWN PLANNING	22/09/2021
1	SCHEMATIC DESIGN	30/08/2021



PROJECT
MONASH MENZIES REDEVELOPMENT - STAGE 2
MONASH UNIVERSITY CLAYTON CAMPUS

DRAWING TITLE
ELEVATIONS - EAST & WEST - DEMOLITION

NORTH

FOR APPROVAL
TOWN PLANNING


SCALE
1:200@A1

JOB No. DRAWN CHECKED DATE
MM08 VK MT SEPT 2021


DRAWING No. REVISION
CL_11_A_6012 3

ALL DIMENSIONS ARE IN MILLIMETERS. DO NOT SCALE DRAWINGS FOR CRITICAL DIMENSIONS. CHECK DRAWING IS TO SCALE BY MEASURING SCALE BAR BELOW. VERIFY ALL DIMENSIONS ON SITE BEFORE COMMENCING ANY WORK, SHOP DRAWINGS OR ORDERING MATERIALS.


FILE: BIM/360/MONASH MenziesA1_C_9104_Menzies Building_Rewd2021.rvt
PRINTED: 25/11/2021 11:53:56 PM
A1 594 x 841

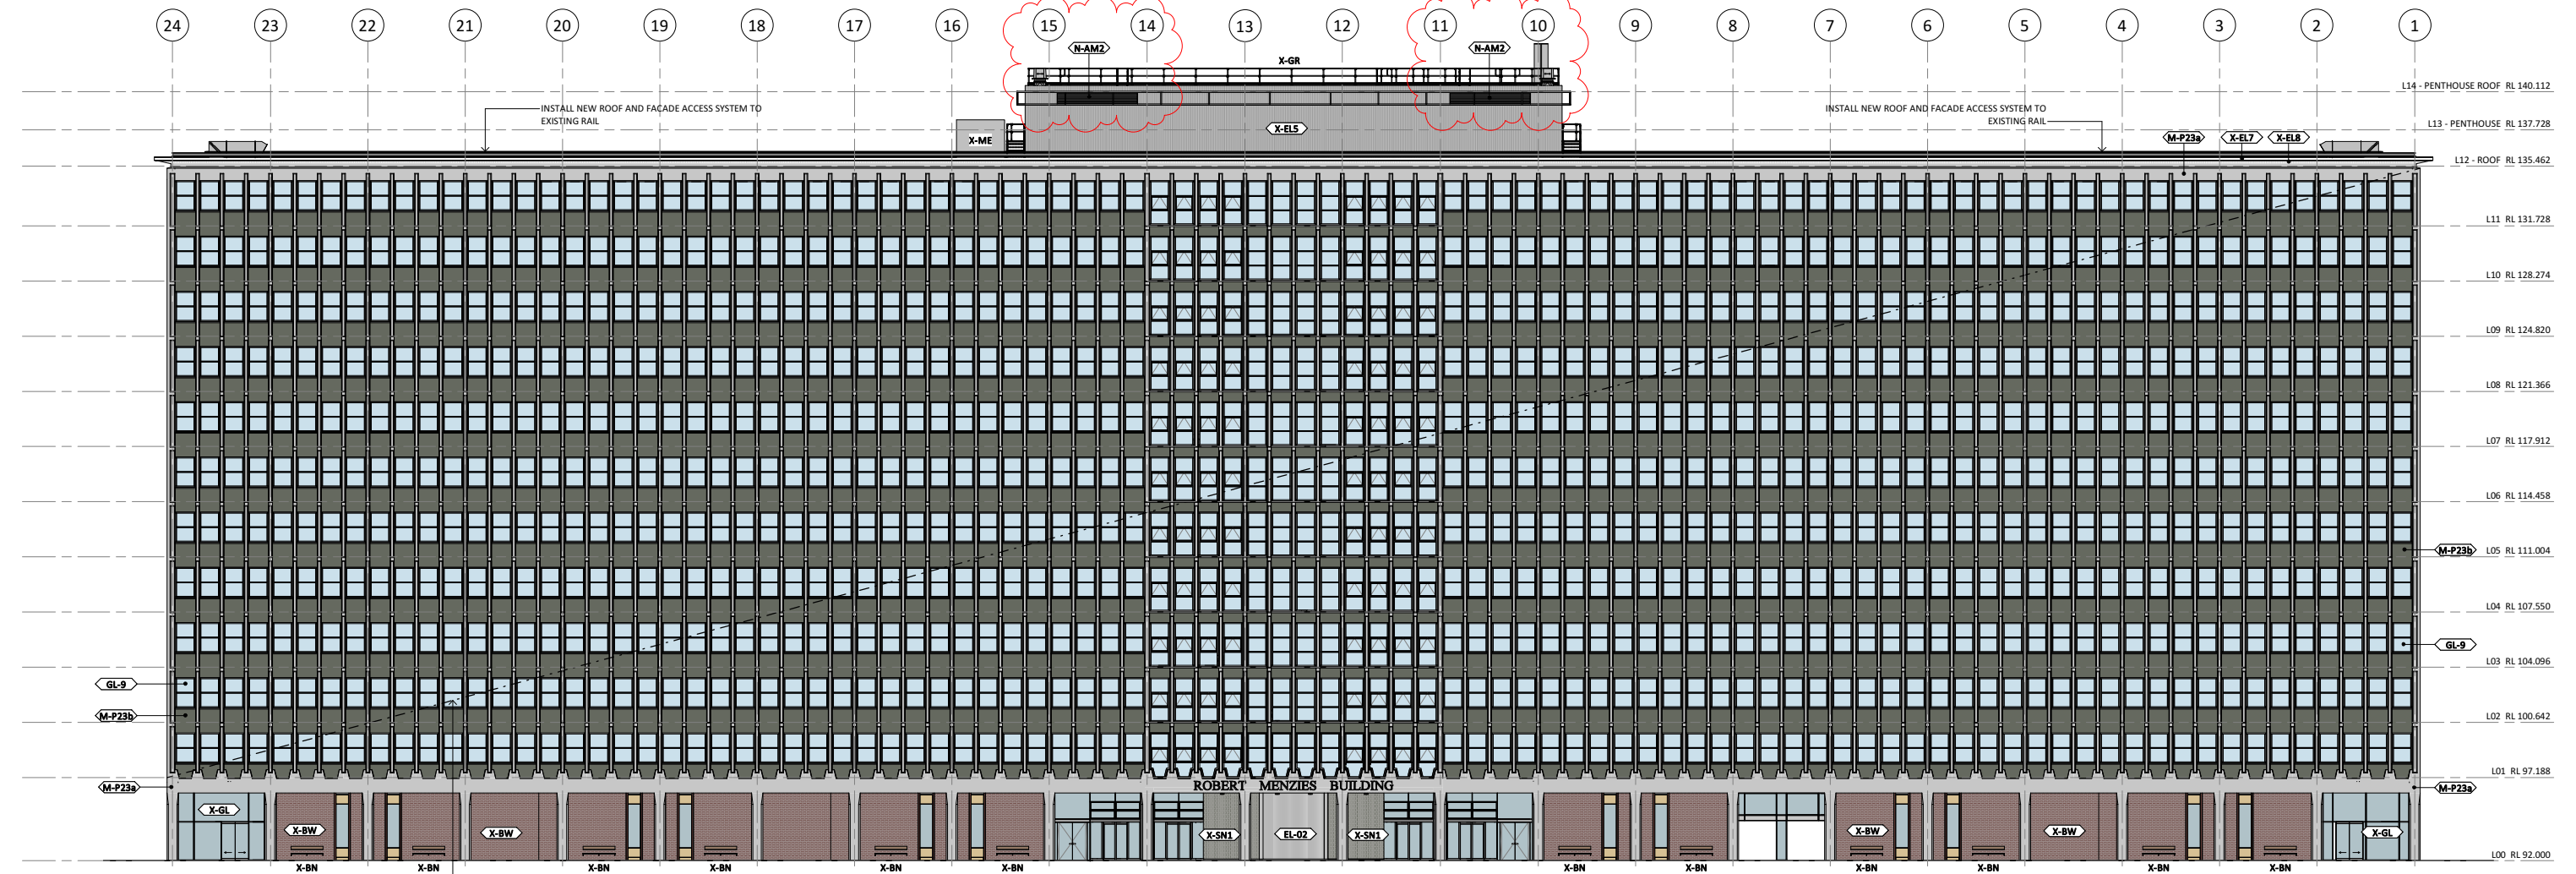

01 ELEVATION - NORTH - PROPOSED
SCALE 1: 200

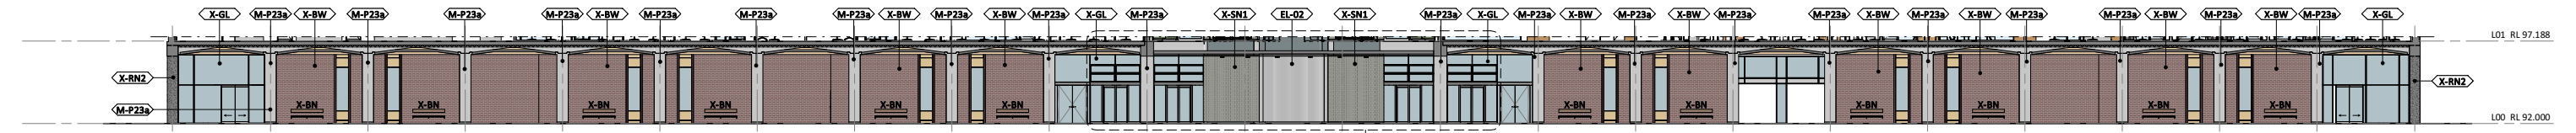

02 ELEVATION - NORTH COLONNADE - PROPOSED
SCALE 1: 200

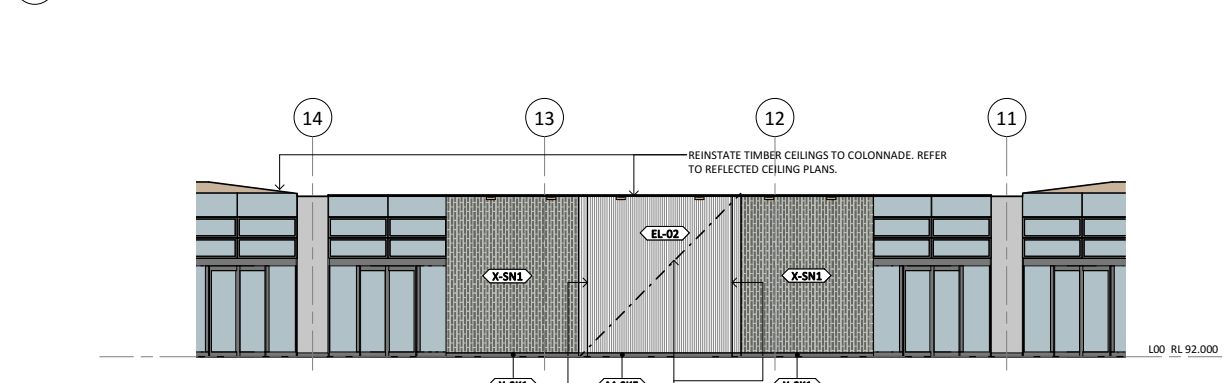

03 INTERNAL ELEVATION - GROUND FLOOR LIFT CLADDING
SCALE 1: 100

WORKS NOTES:

1. SETOUT IS TO BE IN ACCORDANCE WITH ARCHITECTURAL DRAWINGS
2. ALL DESIGN AND INSTALLATION OF ROOFING TO COMPLY WITH AS1562.1.
3. ALL ROOF PLUMBING TO COMPLY WITH AS/NZS 3500.3.2.
4. ALL RAIN WATER GOODS MATERIAL TO COMPLY WITH AS/NZS 2179.1.
5. ALL FLASHING AND CAPPING TO COMPLY WITH AS/NZS 2904.
6. REFER SERVICES ENGINEERS DOCUMENTATION FOR PROPOSED WORKS TO AND CONNECTION TO EXISTING SERVICES. BEFORE COMMENCING WORKS INSPECT THE SITE AND OBTAIN MEASUREMENTS AND OTHER NECESSARY INFORMATION AS REQUIRED
7. ALL NEW SERVICES RETICULATION TO BE CONCEALED

SCOPE NOTES:

1. CLEAN, PREPARE AND PAINT ALL SURFACES WITHIN THE SCOPE OF WORKS AREA, INCLUDING BUT NOT LIMITED TO CONCRETE FACADE ELEMENTS, EXPOSED STRUCTURE AND SERVICES, RAINWATER GOODS AND CLADDING. PROVIDE DETAILED SHOP DRAWINGS INCLUDING BUT NOT LIMITED TO: WINDOWS, DOORS, JOINERY, PARTITION SYSTEMS, CLADDING SYSTEM AND FRAMING SYSTEMS
2. INSTALL NEW HIGH PERFORMANCE ALUMINIUM WINDOWS TO EXTENT INDICATED ON DRAWINGS.
3. INSTALL WINDOW SILLS AND ALUMINIUM TRIMS TO PERIMETER OF SPANDRELS CAVITY.
4. INSTALL NEW MECHANICAL LOUVERS AS SHOWN.
5. INSTALL NEW ROOF AND FACADE ACCESS SYSTEM, REFER ROOF PLAN.
6. INSTALL NON-COMBUSTIBLE ALUMINIUM CLADDING TO THE CENTRAL LIFT TO GROUND FLOOR.

GENERAL NOTES:

1. ALL DRAWINGS ARE TO BE READ IN CONJUNCTION WITH THE ARCHITECTURAL SPECIFICATIONS.
2. ALL DRAWINGS ARE TO BE READ IN CONJUNCTION WITH ALL CONSULTANT DOCUMENTATION.
3. DRAWINGS OF A LARGER SCALE TAKE PRECEDENCE OVER DRAWINGS AT A SMALLER SCALE.
4. ALL EXISTING STRUCTURAL MEMBERS AND FACADE CONSTRUCTION ARE INDICATIVE ONLY. CONTRACTOR IS TO CONFIRM ON SITE EXISTING CONDITION, LEVELS, SIZES AND FIRE RATING TREATMENT.
5. DO NOT SCALE OFF DRAWINGS. USE DIMENSIONS ONLY.
6. ALL DIMENSIONS ARE NOMINAL ONLY. CONTRACTOR TO CONFIRM ALL BUILT AND PROPOSED DIMENSIONS ON SITE PRIOR TO MANUFACTURE OR PREPARING SHOP DRAWINGS.
7. CONTRACTOR IS TO CHECK AND CONFIRM EXISTING CONDITIONS ON SITE, LEVELS, ALIGNMENTS, EXISTING RETAINED STRUCTURE AND ALL OTHER NECESSARY INFORMATION. PRIOR TO COMMENCING ANY WORKS. NOTIFY THE SUPERINTENDENT OF ANY OMISSIONS OR DISCREPANCIES AND SEEK WRITTEN ADVICE PRIOR TO PROCEEDING.

EXTERNAL LEGEND:

- X-BN EXISTING BENCHES
- X-GR EXISTING GUARDRAILS
- X-ME EXISTING MECHANICAL EQUIPMENT
- N-ME NEW MECHANICAL EQUIPMENT. REFER TO MECH. ENGR'S DOCUMENTATION

EXTERNAL FINISHES LEGEND:

- X-BW EXISTING BRICKWORK
- M-P23a EXTERIOR PAINT FINISH - FACADE COLUMNS
- M-P23b EXTERIOR PAINT FINISH - FACADE SPANDRELS
- X-RN1 EXISTING RENDER - PAINT FINISH
- X-RN2 EXISTING RENDER - PAINT FINISH
- X-GL EXISTING GLAZING
- GL-9 HIGH PERFORMANCE EXTERNAL GLAZING - NORTH FACADE
- GL-10 HIGH PERFORMANCE EXTERNAL GLAZING - OTHER FACADES
- EL-01 NEW ALUMINIUM CLADDING - KNUCKLE
- EL-02 NEW REINFORCED PRESSED CEMENT PANEL - NORTH FACADE
- X-EL4 EXISTING CLADDING TO MOSAIC TILES
- X-EL5 EXISTING CORRUGATED WALL CLADDING
- X-EL6 EXISTING ALUMINIUM WALL CLADDING
- X-CON1 EXISTING PRECAST PANEL
- X-EL7 EXISTING FIBRE GLASS FASCIA LINING
- X-EL8 EXISTING RIPPLE IRON SOFFIT LINING
- X-AM1 EXISTING METAL CAPPING
- X-SN1 ORIGINAL STONE CLADDING
- X-AM2 EXISTING ALUMINIUM LOUVRE
- X-AM3 EXISTING METAL SCREEN
- X-RS1 EXISTING ROOF SHEETING - TYPE 1
- X-RS2 EXISTING ROOF SHEETING - TYPE 2
- X-RS3 EXISTING ROOF SHEETING - TYPE 3
- X-EL1 EXISTING METAL WALL CLADDING
- M-P24a EXTERIOR PAINT FINISH - EXISTING METAL WALL CLADDING
- X-CON2 EXTERIOR PAINT FINISH - EXISTING BLOCKWORK WALL
- X-CL1 ORIGINAL TIMBER SLAT CEILING
- X-SK1 ORIGINAL TERRAZZO SKIRTING
- M-SKS NEW TERRAZZO SKIRTING TO MATCH EXISTING
- EL-03 NEW PERFORATED STEEL SCREEN
- EL-04 NEW POWDER COATED STEEL COLUMNS
- N-AM2 NEW ALUMINIUM LOUVRE

ACOUSTIC ENGINEERING
Cundall
L2/330 Little Collins Street
Melbourne, VIC 3000
T (03) 9635 3700
cundall.com

BUILDING SURVEYOR
Steve Watson & Partners
Level 6 / 350 Queen Street
Melbourne, VIC 3000
T (03) 9380 5558
swpartners.com.au

BUILDING SERVICES ENGINEER + ESD
WSP
Level 15/28 Freshwater Place
Southbank, Vic 3006
T (03) 9861 1111
wsp.com

CIVIL, FACADE & STRUCTURE ENGINEERING
WSP
Level 15/28 Freshwater Place
Southbank, Vic 3006
T (03) 9861 1111
wsp.com

DDA CONSULTANT
Architecture & Access
Level 5 / 369 Royal Parade
Parkville, VIC 3052
T 1300 715 866
architectureandaccess.com.au

REV.	DETAILS	DATE
3	TOWN PLANNING	25/11/2021
2	TOWN PLANNING	22/09/2021
1	SCHEMATIC DESIGN	30/08/2021



PROJECT
MONASH MENZIES REDEVELOPMENT - STAGE 2
MONASH UNIVERSITY CLAYTON CAMPUS

DRAWING TITLE
ELEVATIONS - NORTH - PROPOSED

FOR APPROVAL
TOWN PLANNING


SCALE
1:200@A1

JOB No. DRAWN CHECKED DATE
MM08 VK MT SEPT 2021


DRAWING No. REVISION
CL_11_A_6020 3

ALL DIMENSIONS ARE IN MILLIMETERS. DO NOT SCALE DRAWINGS FOR CRITICAL DIMENSIONS. CHECK DRAWING IS TO SCALE BY MEASURING SCALE BAR BELOW. VERIFY ALL DIMENSIONS ON SITE BEFORE COMMENCING ANY WORK. SHOP DRAWINGS OR ORDERING MATERIALS.

FILE: BIM_3601/M08/Monash Menzies/AR_LC_0004_Menzies Building_Rev2021.rvt
 PRINTED: 25/11/2021 11:57:11 AM
 A1 594 x 841

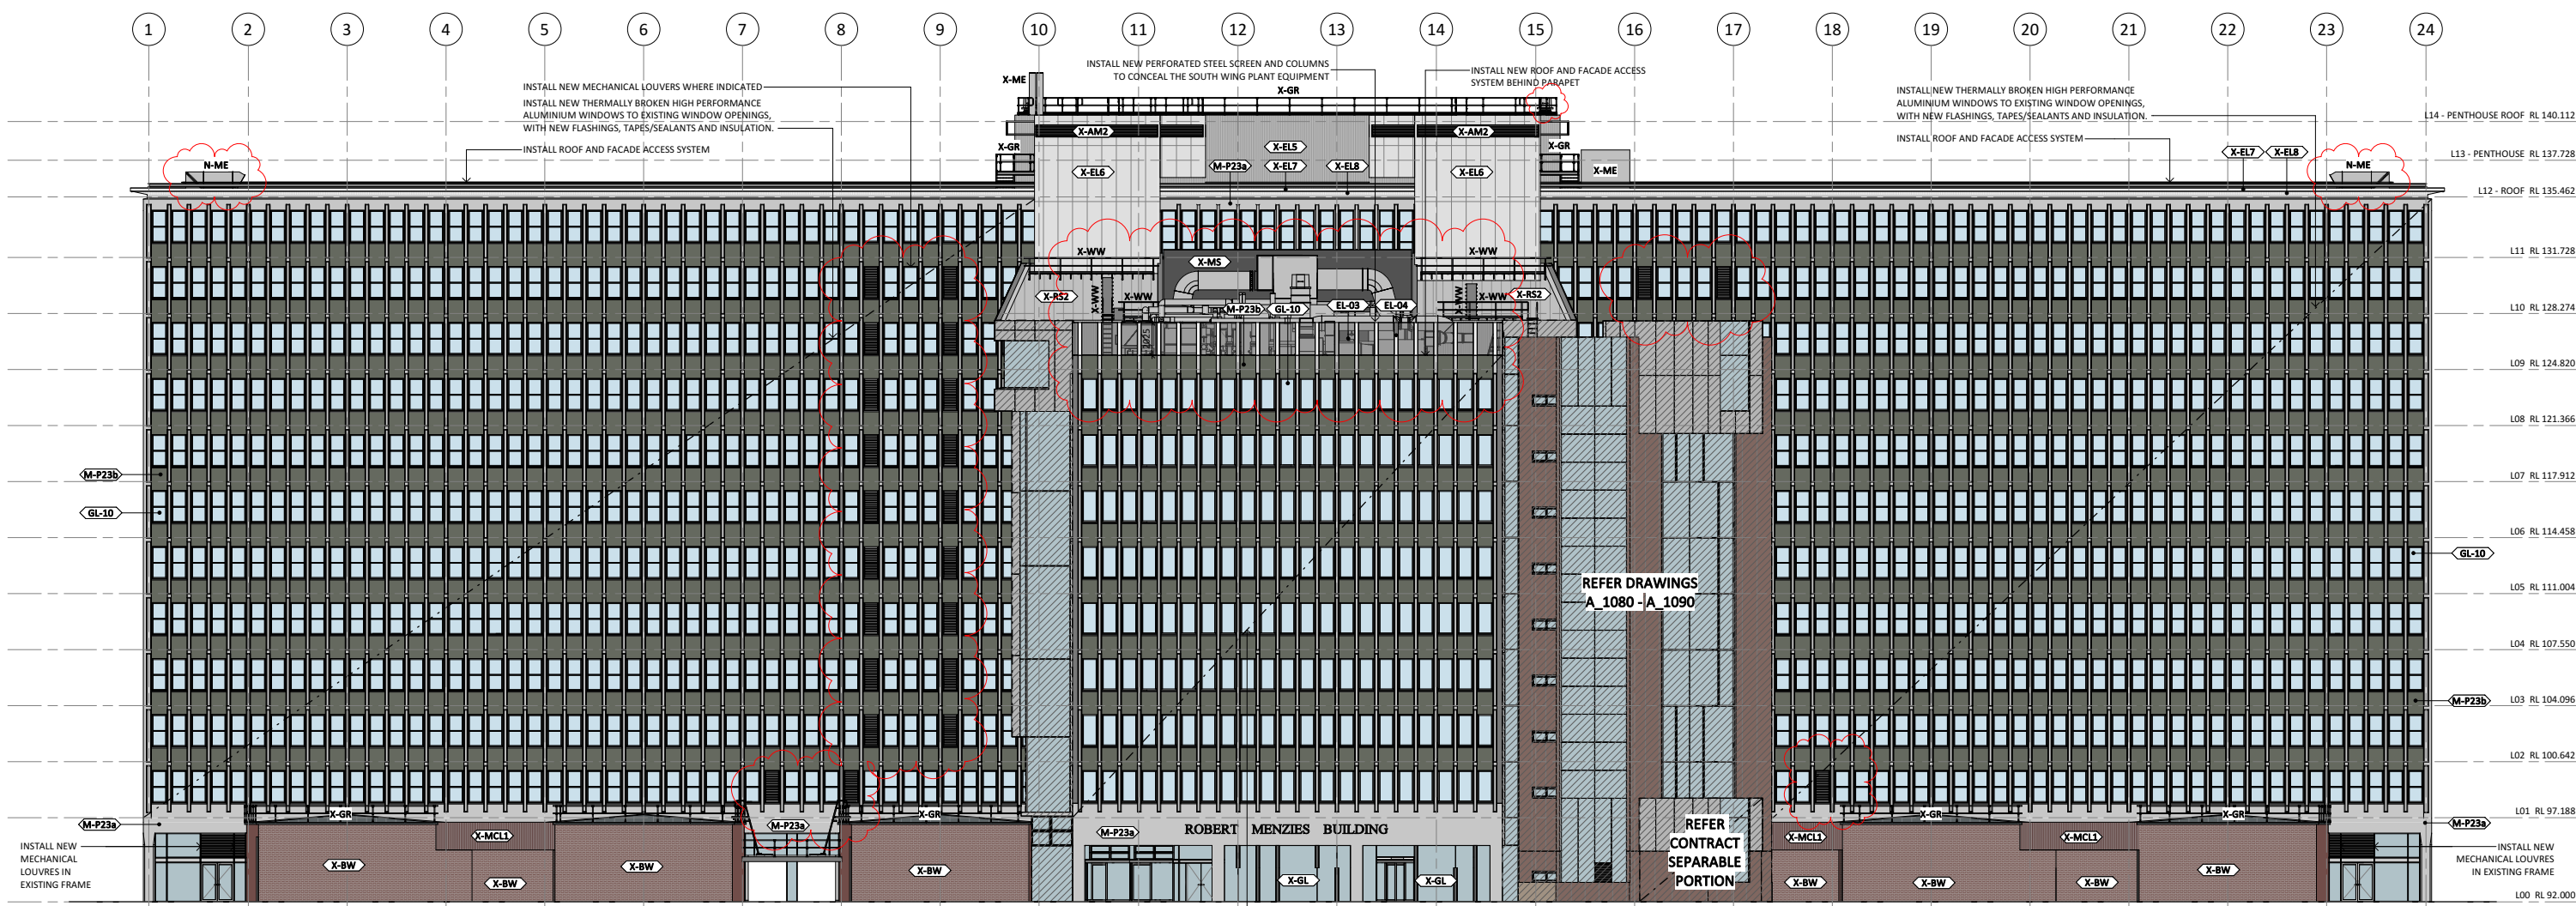

01 ELEVATION - SOUTH - PROPOSED
SCALE 1 : 200

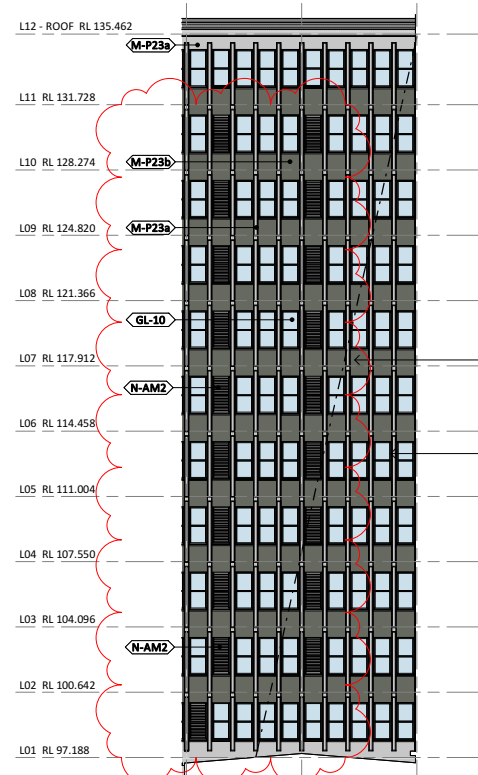

02 ELEVATION - SOUTH - BEYOND LIFT TOWER - PROPOSED
SCALE 1 : 200

EXTERNAL FINISHES LEGEND:

- (X-BW) EXISTING BRICKWORK
- (M-P23a) EXTERIOR PAINT FINISH - FACADE COLUMNS
- (M-P23b) EXTERIOR PAINT FINISH - FACADE SPANDRELS
- (X-RN1) EXISTING RENDER - PAINT FINISH
- (X-RN2) EXISTING RENDER - PAINT FINISH
- (X-GL) EXISTING GLAZING
- (GL-9) HIGH PERFORMANCE EXTERNAL GLAZING - NORTH FACADE
- (GL-10) HIGH PERFORMANCE EXTERNAL GLAZING - OTHER FACADES
- (X-AL) NEW ALUMINIUM CLADDING - KNUCKLE
- (EL-01) NEW REINFORCED PRESSED CEMENT PANEL - NORTH FACADE
- (X-ELS) EXISTING CORRUGATED WALL CLADDING
- (X-EL6) EXISTING ALUMINIUM WALL CLADDING
- (X-COM1) EXISTING PRECAST PANEL
- (X-EL7) EXISTING FIBRE GLASS FASCIA LINING
- (X-EL8) EXISTING RIPPLE IRON SOFFIT LINING
- (X-AM1) EXISTING METAL CAPPING
- (X-SN1) ORIGINAL STONE CLADDING
- (X-AM2) EXISTING ALUMINIUM LOUVRE
- (X-AM3) EXISTING METAL SCREEN
- (X-RS1) EXISTING ROOF SHEETING - TYPE 1
- (X-RS2) EXISTING ROOF SHEETING - TYPE 2
- (X-RS3) EXISTING ROOF SHEETING - TYPE 3
- (X-EL1) EXISTING METAL WALL CLADDING
- (M-P24) EXTERIOR PAINT FINISH - EXISTING METAL WALL CLADDING
- (X-COM2) EXTERIOR PAINT FINISH - EXISTING BLOCKWORK WALL
- (X-CL1) ORIGINAL TERRAZZO SLAT CEILING
- (X-SK1) NEW TERRAZZO SKIRTING
- (M-SK5) NEW TERRAZZO SKIRTING TO MATCH EXISTING
- (EL-03) NEW PERFORATED STEEL SCREEN
- (EL-04) NEW POWDER COATED STEEL COLUMNS
- (N-AM2) NEW ALUMINIUM LOUVRE

EXTERNAL LEGEND:

- X-BN EXISTING BENCHES
- X-GR EXISTING GUARDRAILS
- X-ME EXISTING MECHANICAL EQUIPMENT
- N-ME NEW MECHANICAL EQUIPMENT. REFER TO MECH. ENGR'S DOCUMENTATION

GENERAL NOTES:

1. ALL DRAWINGS ARE TO BE READ IN CONJUNCTION WITH THE ARCHITECTURAL SPECIFICATIONS.
2. ALL DRAWINGS ARE TO BE READ IN CONJUNCTION WITH ALL CONSULTANT DOCUMENTATION.
3. DRAWINGS OF A LARGER SCALE TAKE PRECEDENCE OVER DRAWINGS AT A SMALLER SCALE.
4. ALL EXISTING STRUCTURAL MEMBERS AND FACADE CONSTRUCTION ARE INDICATIVE ONLY. CONTRACTOR IS TO CONFIRM ON SITE EXISTING CONDITION, LEVELS, SIZES AND FIRE RATING TREATMENT.
5. DO NOT SCALE OFF DRAWINGS, USE DIMENSIONS ONLY.
6. ALL DIMENSIONS ARE NOMINAL ONLY. CONTRACTOR TO CONFIRM ALL BUILT AND PROPOSED DIMENSIONS ON SITE PRIOR TO MANUFACTURE OR PREPARING SHOP DRAWINGS.
7. CONTRACTOR IS TO CHECK AND CONFIRM EXISTING CONDITIONS ON SITE, LEVELS, ALIGNMENTS, EXISTING RETAINED STRUCTURE AND ALL OTHER NECESSARY INFORMATION, PRIOR TO COMMENCING ANY WORKS. NOTIFY THE SUPERINTENDENT OF ANY OMISSIONS OR DISCREPANCIES AND SEEK WRITTEN ADVICE PRIOR TO PROCEEDING.

SCOPE NOTES:

1. CLEAN, PREPARE AND PAINT ALL SURFACES WITHIN THE SCOPE OF WORKS AREA, INCLUDING BUT NOT LIMITED TO CONCRETE FACADE ELEMENTS, EXPOSED STRUCTURE AND SERVICES, RAINWATER GOODS AND CLADDING. PROVIDE DETAILED SHOP DRAWINGS INCLUDING BUT NOT LIMITED TO: WINDOWS, DOORS, JOINERY, PARTITION SYSTEMS, CLADDING SYSTEM AND FRAMING SYSTEMS.
2. INSTALL NEW HIGH PERFORMANCE ALUMINIUM WINDOWS TO EXTENT INDICATED ON DRAWINGS.
3. INSTALL WINDOW SILLS AND ALUMINIUM TRIMS TO PERIMETER OF SPANDRELS CAVITY.
4. INSTALL NEW MECHANICAL LOUVERS AS SHOWN.
5. INSTALL NEW ROOF AND FACADE ACCESS SYSTEM, REFER ROOF PLAN.
6. INSTALL NON-COMBUSTIBLE ALUMINIUM CLADDING TO THE CENTRAL LIFT TO GROUND FLOOR.

WORKS NOTES:

1. SETOUT IS TO BE IN ACCORDANCE WITH ARCHITECTURAL DRAWINGS
2. ALL DESIGN AND INSTALLATION OF ROOFING TO COMPLY WITH AS1562.1.
3. ALL ROOF PLUMBING TO COMPLY WITH AS/NZS 3500.3.2.
4. ALL RAIN WATER GOODS MATERIAL TO COMPLY WITH AS/NZS 2179.1.
5. ALL FLASHING AND CAPPING TO COMPLY WITH AS/NZS 2904.
6. REFER SERVICES ENGINEERS DOCUMENTATION FOR PROPOSED WORKS TO AND CONNECTION TO EXISTING SERVICES. BEFORE COMMENCING WORKS INSPECT THE SITE AND OBTAIN MEASUREMENTS AND OTHER NECESSARY INFORMATION AS REQUIRED
7. ALL NEW SERVICES RETICULATION TO BE CONCEALED

ACOUSTIC ENGINEERING
Cundall
L2/330 Little Collins Street
Melbourne, VIC 3000
T (03) 9635 3700
cundall.com

BUILDING SURVEYOR
Steve Watson & Partners
Level 6/ 350 Queen Street
Melbourne, VIC 3000
T (03) 9380 5558
swpartners.com.au

BUILDING SERVICES ENGINEER + ESD
WSP
Level 15/28 Freshwater Place
Southbank, Vic 3006
T (03) 9661 1111
wsp.com

CIVIL, FACADE & STRUCTURE ENGINEERING
WSP
Level 15/28 Freshwater Place
Southbank, Vic 3006
T (03) 9661 1111
wsp.com

DDA CONSULTANT
Architecture & Access
Level 5/ 369 Royal Parade
Parkville, VIC 3052
T 1300 715 866
architectureandaccess.com.au

REV.	DETAILS	DATE
3	TOWN PLANNING	25/11/2021
2	TOWN PLANNING	22/09/2021
1	SCHEMATIC DESIGN	30/08/2021



PROJECT
MONASH MENZIES REDEVELOPMENT - STAGE 2
MONASH UNIVERSITY CLAYTON CAMPUS

DRAWING TITLE
ELEVATIONS - SOUTH - PROPOSED

NORTH


FOR APPROVAL
TOWN PLANNING

SCALE
1:200@A1


JOB No. DRAWN CHECKED DATE
MM08 VK MT SEPT 2021

DRAWING No. REVISION
CL_11_A_6021 3

ALL DIMENSIONS ARE IN MILLIMETERS. DO NOT SCALE DRAWINGS FOR CRITICAL DIMENSIONS. CHECK DRAWING IS TO SCALE BY MEASURING SCALE BAR BELOW. VERIFY ALL DIMENSIONS ON SITE BEFORE COMMENCING ANY WORK. SHOP DRAWINGS OR ORDERING MATERIALS.

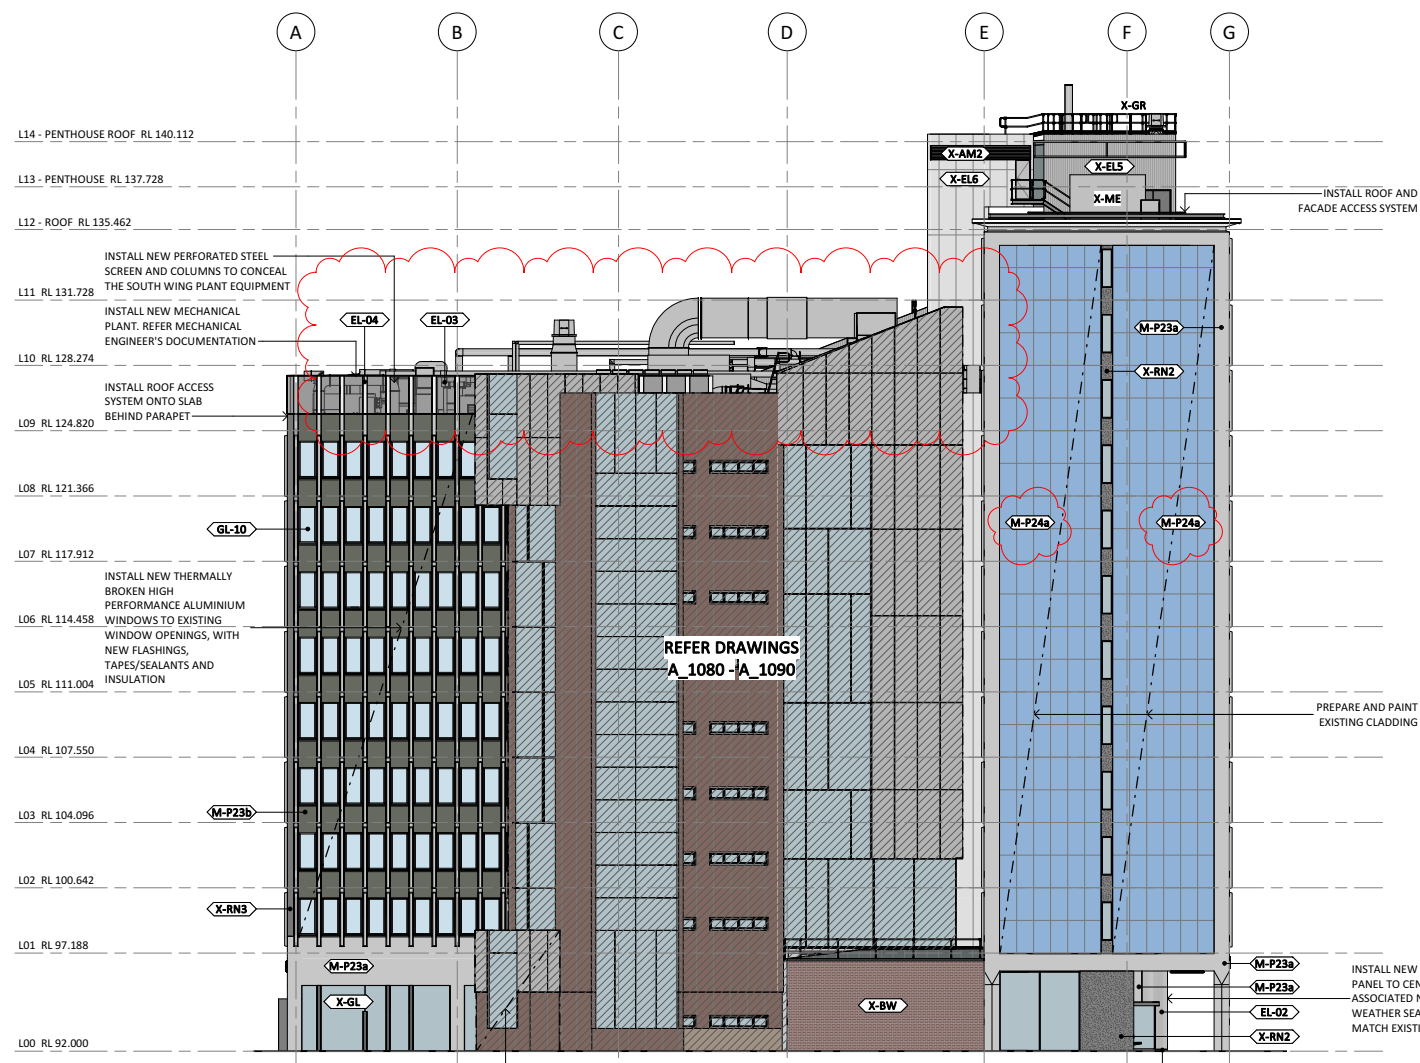

01 ELEVATION - EAST - PROPOSED
SCALE 1 : 200

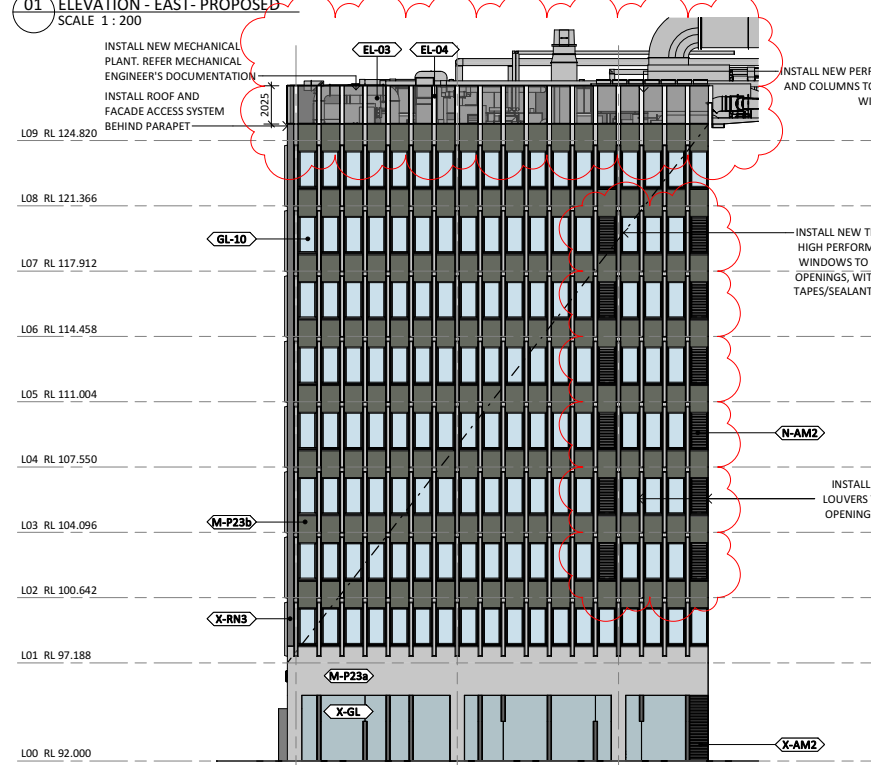

02 ELEVATION - EAST - BEYOND LIFT TOWER - PROPOSED
SCALE 1 : 200

ACOUSTIC ENGINEERING
Cundall
L2/330 Little Collins Street
Melbourne, VIC 3000
T (03) 9638 3700
cundall.com

BUILDING SURVEYOR
Steve Watson & Partners
Level 6/ 350 Queen Street
Melbourne, VIC 3000
T (03) 9380 5558
swpartners.com.au


BUILDING SERVICES ENGINEER + ESD
WSP
Level 15/28 Freshwater Place
Southbank, Vic 3006
T (03) 9861 1111
wsp.com

CIVIL, FACADE & STRUCTURE ENGINEERING
WSP
Level 15/28 Freshwater Place
Southbank, Vic 3006
T (03) 9861 1111
wsp.com

DDA CONSULTANT
Architecture & Access
Level 5/ 369 Royal Parade
Parkville, VIC 3052
T 1300 715 866
architectureandaccess.com.au

REV.	DETAILS	DATE
3	TOWN PLANNING	25/11/2021
2	TOWN PLANNING	22/09/2021
1	SCHEMATIC DESIGN	30/08/2021

CLIENT
MONASH University

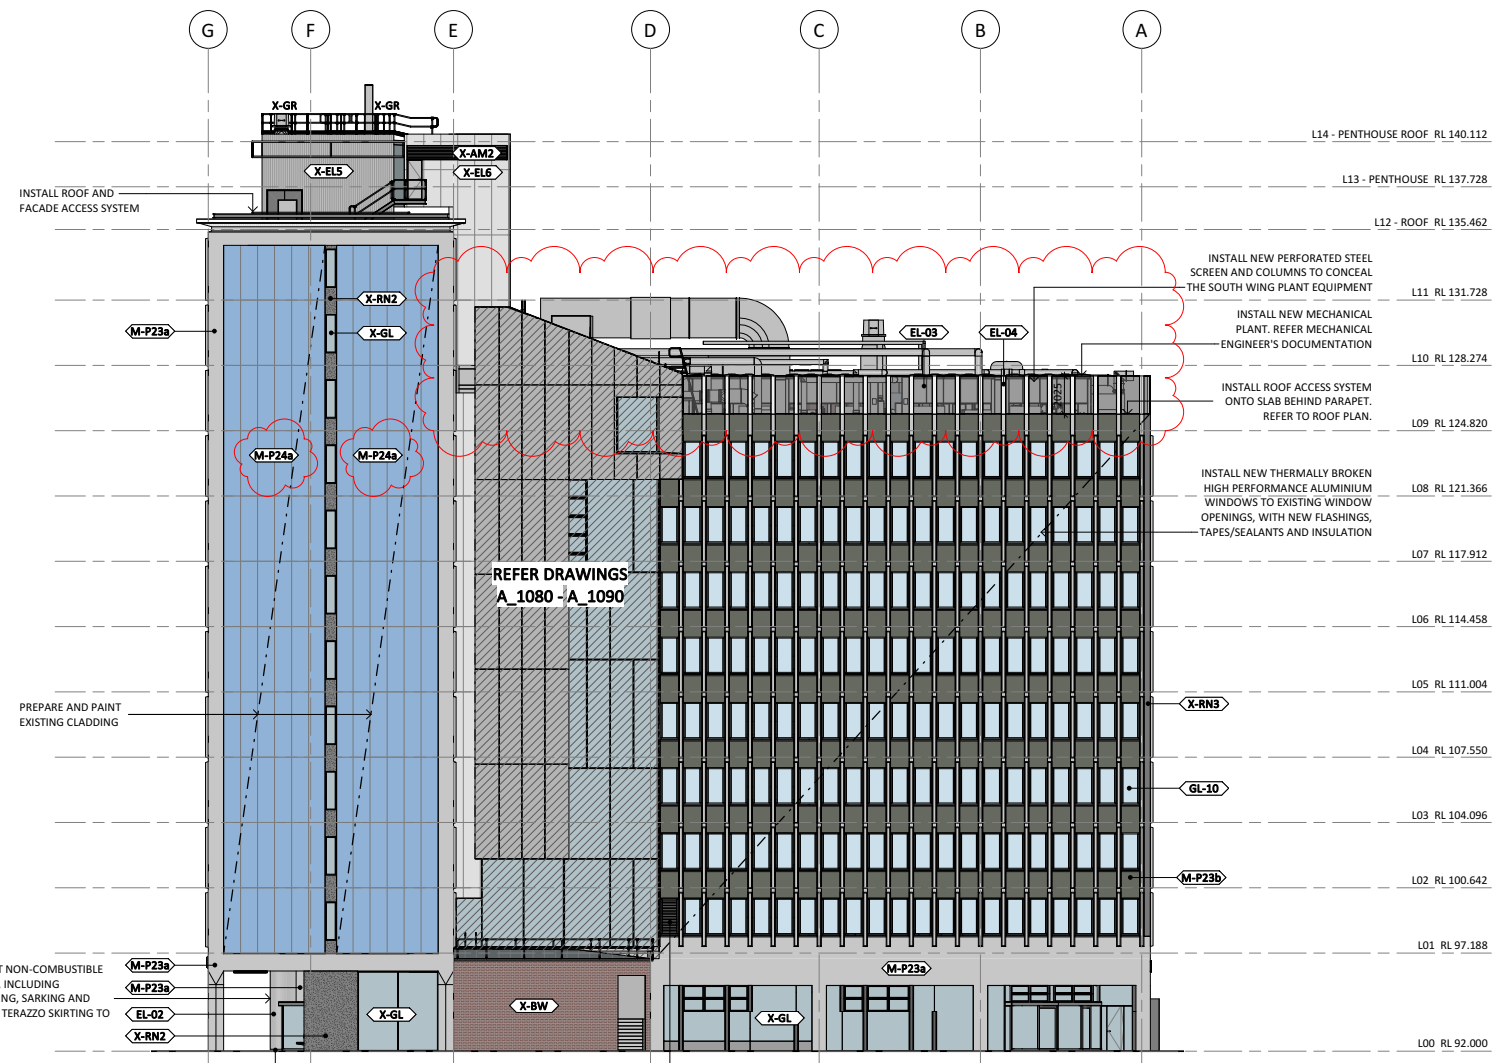

03 ELEVATION - WEST - PROPOSED
SCALE 1 : 200



04 ELEVATION - WEST - BEYOND LIFT TOWER - PROPOSED
SCALE 1 : 200

PROJECT
MONASH MENZIES REDEVELOPMENT - STAGE 2
MONASH UNIVERSITY CLAYTON CAMPUS

DRAWING TITLE
ELEVATIONS - EAST & WEST - PROPOSED

CLIENT
MONASH University

PROJECT
Lyons +
LOVELL CHEN STUDIOBIRD

- EXTERNAL FINISHES LEGEND:**
- X-BW EXISTING BRICKWORK
 - M-P23a EXTERIOR PAINT FINISH - FACADE COLUMNS
 - M-P23b EXTERIOR PAINT FINISH - FACADE SPANDRELS
 - X-RN1 EXISTING RENDER - PAINT FINISH
 - X-RN2 EXISTING RENDER - PAINT FINISH
 - X-GL EXISTING GLAZING
 - GL-9 HIGH PERFORMANCE EXTERNAL GLAZING - NORTH FACADE
 - GL-10 HIGH PERFORMANCE EXTERNAL GLAZING - OTHER FACADES
 - EL-01 NEW ALUMINIUM CLADDING - KNUCKLE
 - EL-02 NEW REINFORCED PRESSED CEMENT PANEL - NORTH FACADE
 - X-EL4 EXISTING CLADDING TO MOSAIC TILES
 - X-EL5 EXISTING CORRUGATED WALL CLADDING
 - X-EL6 EXISTING ALUMINIUM WALL CLADDING
 - X-CON1 EXISTING PRECAST PANEL
 - X-EL7 EXISTING FIBRE GLASS FASCIA LINING
 - X-EL8 EXISTING RIPPLE IRON SOFFIT LINING
 - X-AM1 EXISTING METAL CAPPING
 - X-SN1 ORIGINAL STONE CLADDING
 - X-AM2 EXISTING ALUMINIUM LOUVRE
 - X-AM3 EXISTING METAL SCREEN
 - X-RS1 EXISTING ROOF SHEETING - TYPE 1
 - X-RS2 EXISTING ROOF SHEETING - TYPE 2
 - X-RS3 EXISTING ROOF SHEETING - TYPE 3
 - X-EL1 EXISTING METAL WALL CLADDING
 - M-P24a EXTERIOR PAINT FINISH - EXISTING METAL WALL CLADDING
 - X-CON2 EXTERIOR PAINT FINISH - EXISTING BLOCKWORK WALL
 - X-CL1 ORIGINAL TIMBER SLAT CEILING
 - X-SK1 ORIGINAL TERRAZZO SKIRTING
 - M-SKS NEW TERRAZZO SKIRTING TO MATCH EXISTING
 - EL-03 NEW PERFORATED STEEL SCREEN
 - EL-04 NEW POWDER COATED STEEL COLUMNS
 - N-AM2 NEW ALUMINIUM LOUVRE
- EXTERNAL LEGEND:**
- X-BN EXISTING BENCHES
 - X-GR EXISTING GUARDRAILS
 - X-ME EXISTING MECHANICAL EQUIPMENT
 - N-ME NEW MECHANICAL EQUIPMENT. REFER TO MECH. ENGR'S DOCUMENTATION

- GENERAL NOTES:**
- ALL DRAWINGS ARE TO BE READ IN CONJUNCTION WITH THE ARCHITECTURAL SPECIFICATIONS.
 - ALL DRAWINGS ARE TO BE READ IN CONJUNCTION WITH ALL CONSULTANT DOCUMENTATION.
 - DRAWINGS OF A LARGER SCALE TAKE PRECEDENCE OVER DRAWINGS AT A SMALLER SCALE.
 - ALL EXISTING STRUCTURAL MEMBERS AND FACADE CONSTRUCTION ARE INDICATIVE ONLY. CONTRACTOR IS TO CONFIRM ON SITE EXISTING CONDITION, LEVELS, SIZES AND FIRE RATING TREATMENT.
 - DO NOT SCALE OFF DRAWINGS. USE DIMENSIONS ONLY.
 - ALL DIMENSIONS ARE NOMINAL ONLY. CONTRACTOR TO CONFIRM ALL BUILT AND PROPOSED DIMENSIONS ON SITE PRIOR TO MANUFACTURE OR PREPARING SHOP DRAWINGS.
 - CONTRACTOR IS TO CHECK AND CONFIRM EXISTING CONDITIONS ON SITE, LEVELS, ALIGNMENTS, EXISTING RETAINED STRUCTURE AND ALL OTHER NECESSARY INFORMATION, PRIOR TO COMMENCING ANY WORKS. NOTIFY THE SUPERINTENDENT OF ANY OMISSIONS OR DISCREPANCIES AND SEEK WRITTEN ADVICE PRIOR TO PROCEEDING.
- SCOPE NOTES:**
- CLEAN, PREPARE AND PAINT ALL SURFACES WITHIN THE SCOPE OF WORKS AREA, INCLUDING BUT NOT LIMITED TO CONCRETE FACADE ELEMENTS, EXPOSED STRUCTURE AND SERVICES, RAINWATER GOODS AND CLADDING PROVIDE DETAILED SHOP DRAWINGS INCLUDING BUT NOT LIMITED TO: WINDOWS, DOORS, JOINERY, PARTITION SYSTEMS, CLADDING SYSTEM AND FRAMING SYSTEMS
 - INSTALL NEW HIGH PERFORMANCE ALUMINIUM WINDOWS TO EXTENT INDICATED ON DRAWINGS.
 - INSTALL WINDOW SILLS AND ALUMINIUM TRIMS TO PERIMETER OF SPANDRELS CAVITY.
 - INSTALL NEW MECHANICAL LOUVERS AS SHOWN.
 - INSTALL NEW ROOF AND FACADE ACCESS SYSTEM, REFER ROOF PLAN.
 - INSTALL NON-COMBUSTIBLE ALUMINIUM CLADDING TO THE CENTRAL LIFT TO GROUND FLOOR.
- WORKS NOTES:**
- SETOUT IS TO BE IN ACCORDANCE WITH ARCHITECTURAL DRAWINGS
 - ALL DESIGN AND INSTALLATION OF ROOFING TO COMPLY WITH AS1562.1.
 - ALL ROOF PLUMBING TO COMPLY WITH AS/NZS 3500.3.2.
 - ALL RAIN WATER GOODS MATERIAL TO COMPLY WITH AS/NZS 2179.1
 - ALL FLASHING AND CAPPING TO COMPLY WITH AS/NZS 2904.
 - REFER SERVICES ENGINEERS DOCUMENTATION FOR PROPOSED WORKS TO AND CONNECTION TO EXISTING SERVICES. BEFORE COMMENCING WORKS INSPECT THE SITE AND OBTAIN MEASUREMENTS AND OTHER NECESSARY INFORMATION AS REQUIRED
 - ALL NEW SERVICES RETICULATION TO BE CONCEALED

FOR APPROVAL
TOWN PLANNING

SCALE
1:200@A1

JOB No. DRAWN CHECKED DATE
MM08 VK MT SEPT 2021


DRAWING No. REVISION
CL_11_A_6022 3

PROJECT
MONASH MENZIES REDEVELOPMENT - STAGE 2
MONASH UNIVERSITY CLAYTON CAMPUS

DRAWING TITLE
ELEVATIONS - EAST & WEST - PROPOSED

CLIENT
MONASH University

PROJECT
Lyons +
LOVELL CHEN STUDIOBIRD

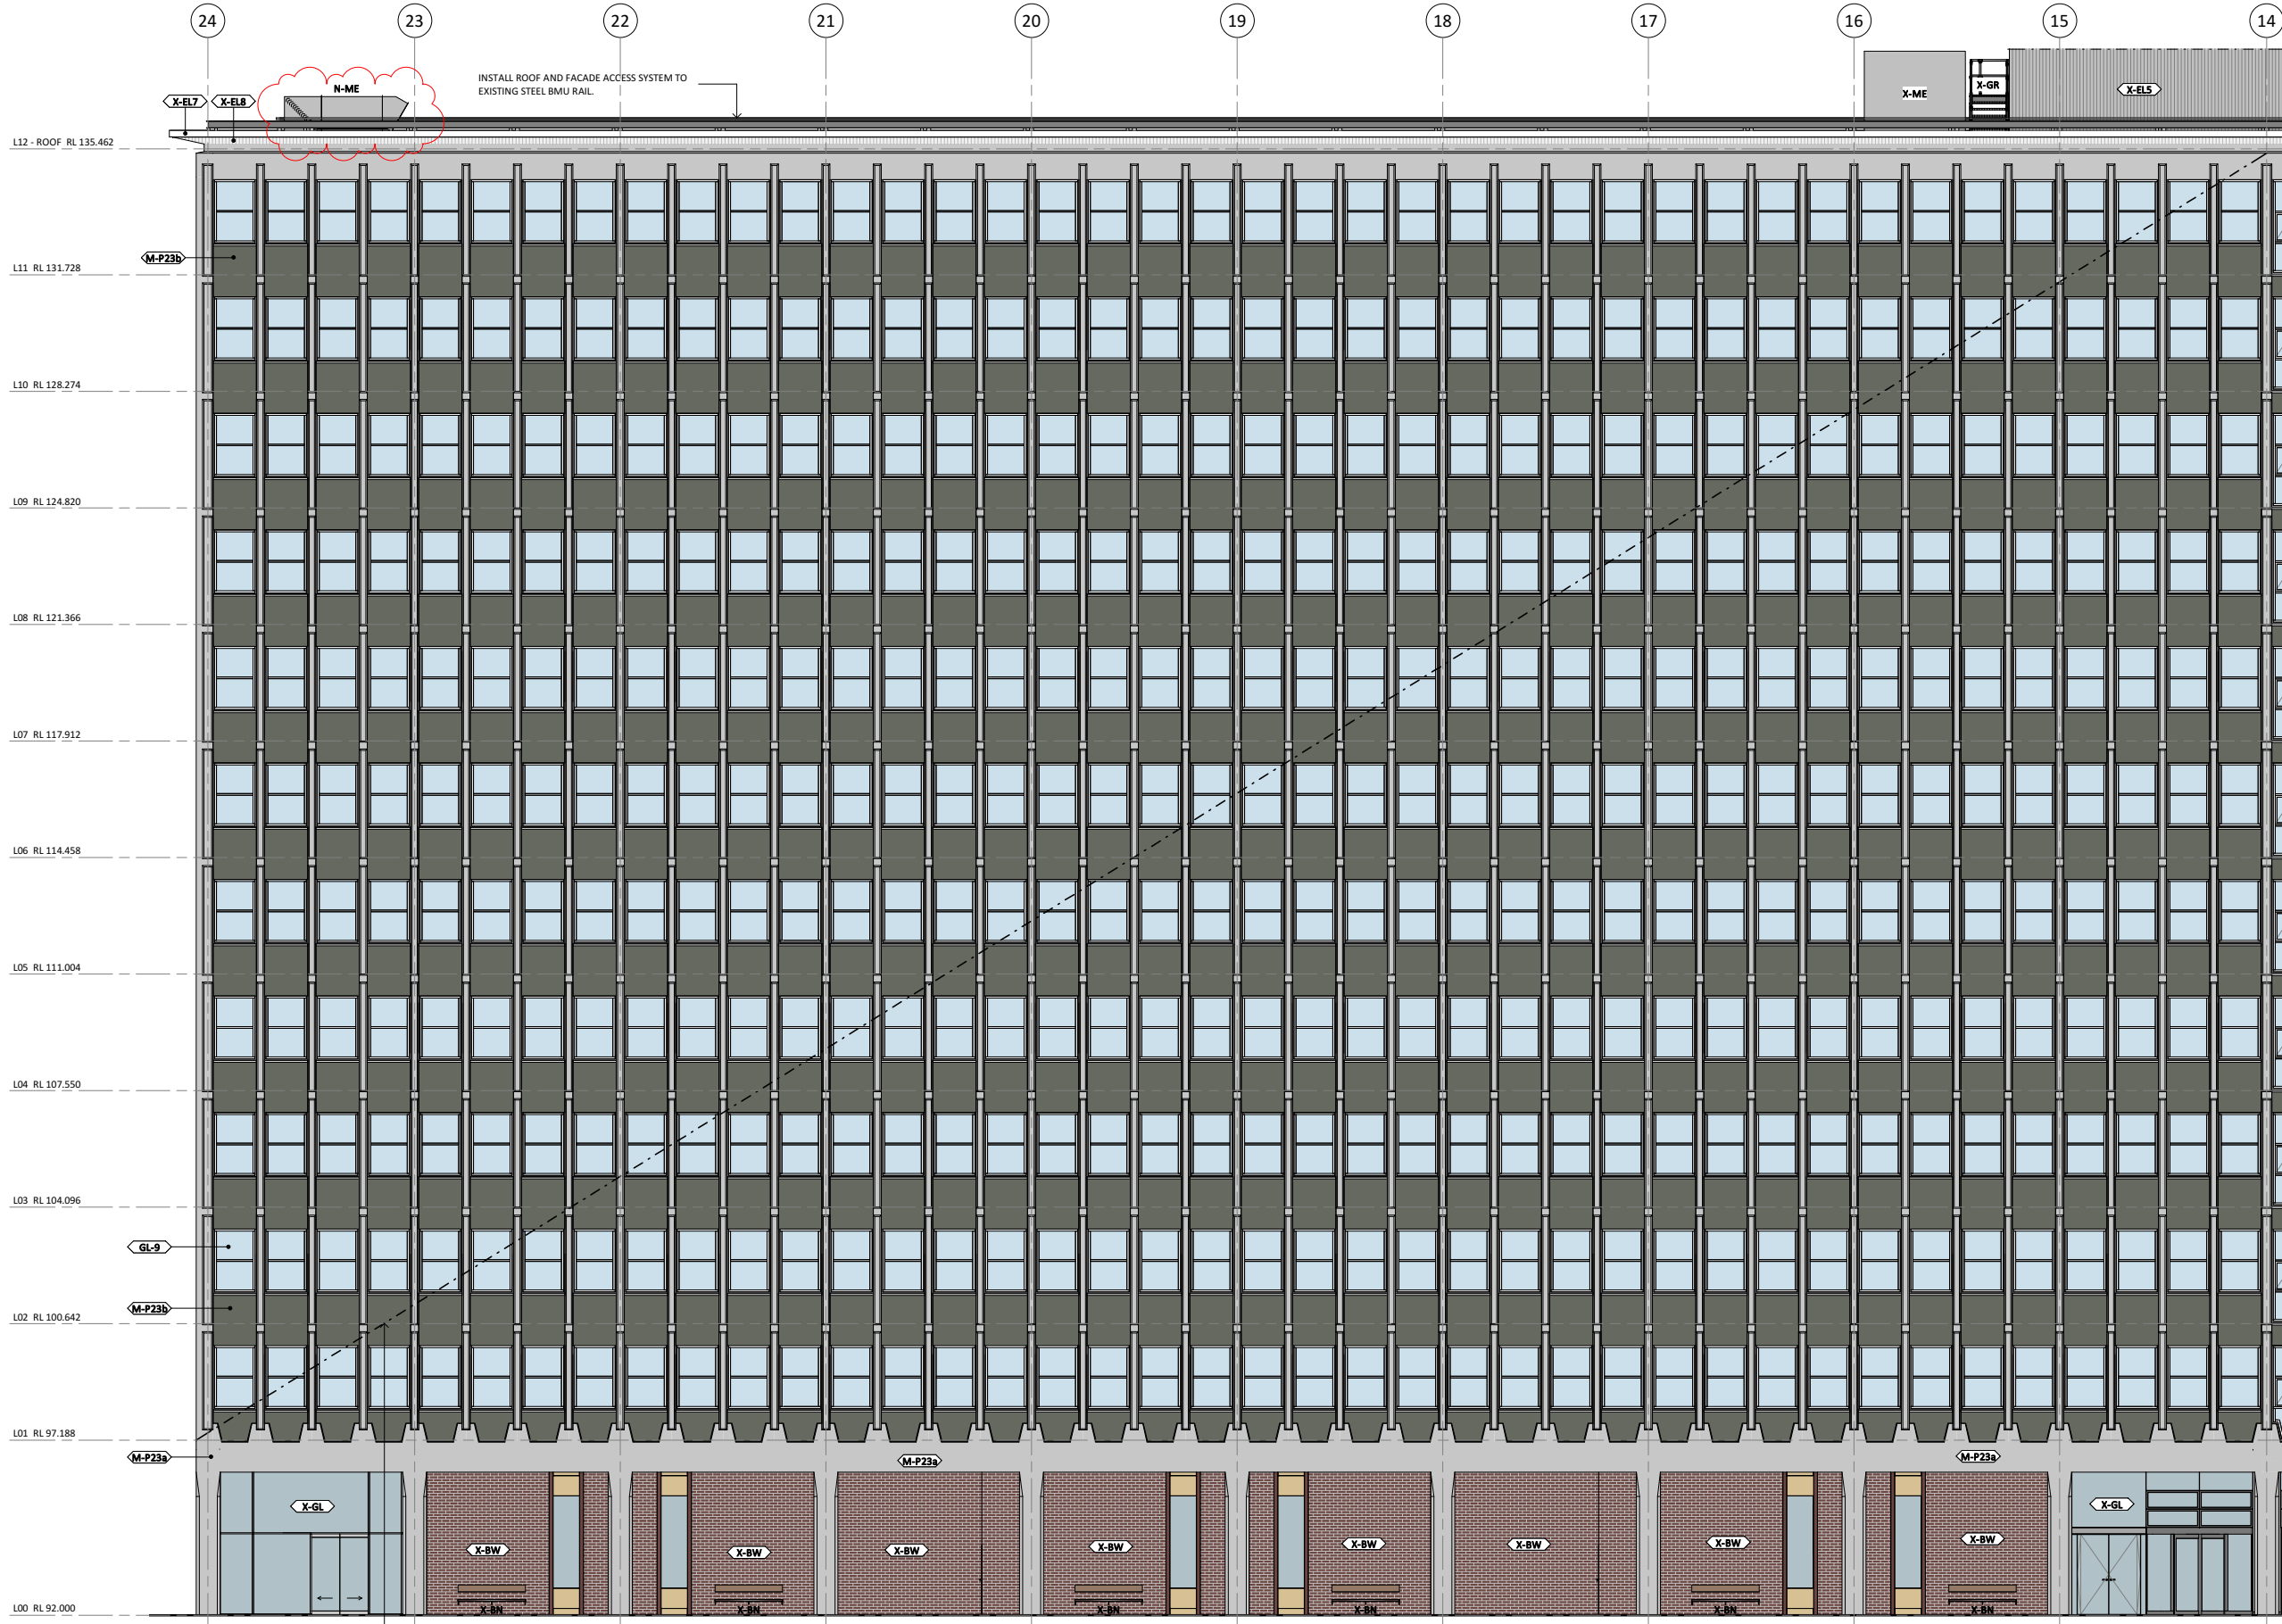

- GENERAL NOTES:**
1. ALL DRAWINGS ARE TO BE READ IN CONJUNCTION WITH THE ARCHITECTURAL SPECIFICATIONS.
 2. ALL DRAWINGS ARE TO BE READ IN CONJUNCTION WITH ALL CONSULTANT DOCUMENTATION.
 3. DRAWINGS OF A LARGER SCALE TAKE PRECEDENCE OVER DRAWINGS AT A SMALLER SCALE.
 4. ALL EXISTING STRUCTURAL MEMBERS AND FACADE CONSTRUCTION ARE INDICATIVE ONLY. CONTRACTOR IS TO CONFIRM ON SITE EXISTING CONDITION, LEVELS, SIZES AND FIRE RATING TREATMENT.
 5. DO NOT SCALE OFF DRAWINGS, USE DIMENSIONS ONLY.
 6. ALL DIMENSIONS ARE NOMINAL ONLY. CONTRACTOR TO CONFIRM ALL BUILT AND PROPOSED DIMENSIONS ON SITE PRIOR TO MANUFACTURE OR PREPARING SHOP DRAWINGS.
 7. CONTRACTOR IS TO CHECK AND CONFIRM EXISTING CONDITIONS ON SITE, LEVELS, ALIGNMENTS, EXISTING RETAINED STRUCTURE AND ALL OTHER NECESSARY INFORMATION, PRIOR TO COMMENCING ANY WORKS. NOTIFY THE SUPERINTENDENT OF ANY OMISSIONS OR DISCREPANCIES AND SEEK WRITTEN ADVICE PRIOR TO PROCEEDING.

- SCOPE NOTES:**
1. CLEAN, PREPARE AND PAINT ALL SURFACES WITHIN THE SCOPE OF WORKS AREA, INCLUDING BUT NOT LIMITED TO CONCRETE FACADE ELEMENTS, EXPOSED STRUCTURE AND SERVICES, RAINWATER GOODS AND CLADDING. PROVIDE DETAILED SHOP DRAWINGS INCLUDING BUT NOT LIMITED TO: WINDOWS, DOORS, JOINERY, PARTITION SYSTEMS, CLADDING SYSTEM AND FRAMING SYSTEMS
 2. INSTALL NEW HIGH PERFORMANCE ALUMINIUM WINDOWS TO EXTENT INDICATED ON DRAWINGS.
 3. INSTALL WINDOW SILLS AND ALUMINIUM TRIMS TO PERIMETER OF SPANDRELS CAVITY.
 4. INSTALL NEW MECHANICAL LOUVERS AS SHOWN.
 5. INSTALL NEW ROOF AND FACADE ACCESS SYSTEM, REFER ROOF PLAN.
 6. INSTALL NON-COMBUSTIBLE ALUMINIUM CLADDING TO THE CENTRAL LIFT TO GROUND FLOOR.

- WORKS NOTES:**
1. SETOUT IS TO BE IN ACCORDANCE WITH ARCHITECTURAL DRAWINGS
 2. ALL DESIGN AND INSTALLATION OF ROOFING TO COMPLY WITH AS1562.1.
 3. ALL ROOF PLUMBING TO COMPLY WITH AS/NZS 3500.3.2.
 4. ALL RAIN WATER GOODS MATERIAL TO COMPLY WITH AS/NZS 2179.1.
 5. ALL FLASHING AND CAPPING TO COMPLY WITH AS/NZS 2904.
 6. REFER SERVICES ENGINEERS DOCUMENTATION FOR PROPOSED WORKS TO AND CONNECTION TO EXISTING SERVICES. BEFORE COMMENCING WORKS INSPECT THE SITE AND OBTAIN MEASUREMENTS AND OTHER NECESSARY INFORMATION AS REQUIRED
 7. ALL NEW SERVICES RETICULATION TO BE CONCEALED

- EXTERNAL FINISHES LEGEND:**
- X-BW EXISTING BRICKWORK
 - M-P23a EXTERIOR PAINT FINISH - FACADE COLUMNS
 - M-P23b EXTERIOR PAINT FINISH - FACADE SPANDRELS
 - X-RN1 EXISTING RENDER - PAINT FINISH
 - X-RN2 EXISTING RENDER - PAINT FINISH
 - X-GL EXISTING GLAZING
 - GL-9 HIGH PERFORMANCE EXTERNAL GLAZING - NORTH FACADE
 - GL-10 HIGH PERFORMANCE EXTERNAL GLAZING - OTHER FACADES
 - EL-01 NEW ALUMINIUM CLADDING - KNUCKLE
 - EL-02 NEW REINFORCED PRESSED CEMENT PANEL - NORTH FACADE
 - X-EL4 EXISTING CLADDING TO MOSAIC TILES
 - X-EL5 EXISTING CORRUGATED WALL CLADDING
 - X-EL6 EXISTING ALUMINIUM WALL CLADDING
 - X-CON1 EXISTING PRECAST PANEL
 - X-EL7 EXISTING FIBRE GLASS FASCIA LINING
 - X-EL8 EXISTING RIPPLE IRON SOFFIT LINING
 - X-AM1 EXISTING METAL CAPPING
 - X-SM1 ORIGINAL STONE CLADDING
 - X-AM2 EXISTING ALUMINIUM LOUVER
 - X-AM3 EXISTING METAL SCREEN
 - X-RS1 EXISTING ROOF SHEETING - TYPE 1
 - X-RS2 EXISTING ROOF SHEETING - TYPE 2
 - X-RS3 EXISTING ROOF SHEETING - TYPE 3
 - X-EL1 EXISTING METAL WALL CLADDING
 - M-P23c EXTERIOR PAINT FINISH - EXISTING METAL WALL CLADDING
 - X-CON2 EXTERIOR PAINT FINISH - EXISTING BLOCKWORK WALL
 - X-CL1 ORIGINAL TIMBER SLAT CEILING
 - X-SK1 ORIGINAL TERRAZZO SKIRTING
 - M-SK5 NEW TERRAZZO SKIRTING TO MATCH EXISTING
 - EL-03 NEW PERFORATED STEEL SCREEN
 - EL-04 NEW POWDER COATED STEEL COLUMNS
 - N-AM2 NEW ALUMINIUM LOUVER

- EXTERNAL LEGEND:**
- X-BN EXISTING BENCHES
 - X-GR EXISTING GUARDRAILS
 - X-ME EXISTING MECHANICAL EQUIPMENT
 - N-ME NEW MECHANICAL EQUIPMENT. REFER TO MECH. ENGR'S DOCUMENTATION

ACOUSTIC ENGINEERING
Cundall
 L2/330 Little Collins Street
 Melbourne, VIC 3000
 T (03) 9635 3700
 cundall.com

BUILDING SURVEYOR
Steve Watson & Partners
 Level 6/ 350 Queen Street
 Melbourne, VIC 3000
 T (03) 9380 5558
 swpartners.com.au

BUILDING SERVICES ENGINEER + ESD
WSP
 Level 15/28 Freshwater Place
 Southbank, Vic 3006
 T (03) 9861 1111
 wsp.com

CIVIL, FACADE & STRUCTURE ENGINEERING
WSP
 Level 15/28 Freshwater Place
 Southbank, Vic 3006
 T (03) 9861 1111
 wsp.com

DCA CONSULTANT
Architecture & Access
 Level 5/ 369 Royal Parade
 Parkville, VIC 3052
 T 1300 715 866
 architectureandaccess.com.au

REV.	DETAILS	DATE
3	TOWN PLANNING	25/11/2021
2	TOWN PLANNING	22/09/2021
1	SCHEMATIC DESIGN	30/08/2021



PROJECT
MONASH MENZIES REDEVELOPMENT - STAGE 2
 MONASH UNIVERSITY CLAYTON CAMPUS

DRAWING TITLE
PART NORTH ELEVATION EAST

NORTH

FOR APPROVAL
 TOWN PLANNING

SCALE
 1:100@A1

JOB No.	DRAWN	CHECKED	DATE
MM08	VK	MT	SEPT 2021

DRAWING No. CL_11_A_6023

REVISION
3

ALL DIMENSIONS ARE IN MILLIMETERS. DO NOT SCALE DRAWINGS FOR CRITICAL DIMENSIONS. CHECK DRAWING IS TO SCALE BY MEASURING SCALE BAR BELOW. VERIFY ALL DIMENSIONS ON SITE BEFORE COMMENCING ANY WORK, SHOP DRAWINGS OR ORDERING MATERIALS.

FILE: BIM_360/MN08/Monash Menzies/AR_LC_6004_Menzies Building_Rev4/2021.rvt
 PRINTED: 25/11/2021 11:58:35 AM
 A1 594 x 841



- GENERAL NOTES:**
1. ALL DRAWINGS ARE TO BE READ IN CONJUNCTION WITH THE ARCHITECTURAL SPECIFICATIONS.
 2. ALL DRAWINGS ARE TO BE READ IN CONJUNCTION WITH ALL CONSULTANT DOCUMENTATION.
 3. DRAWINGS OF A LARGER SCALE TAKE PRECEDENCE OVER DRAWINGS AT A SMALLER SCALE.
 4. ALL EXISTING STRUCTURAL MEMBERS AND FACADE CONSTRUCTION ARE INDICATIVE ONLY. CONTRACTOR IS TO CONFIRM ON SITE EXISTING CONDITION, LEVELS, SIZES AND FIRE RATING TREATMENT.
 5. DO NOT SCALE OFF DRAWINGS, USE DIMENSIONS ONLY.
 6. ALL DIMENSIONS ARE NOMINAL ONLY. CONTRACTOR TO CONFIRM ALL BUILT AND PROPOSED DIMENSIONS ON SITE PRIOR TO MANUFACTURE OR PREPARING SHOP DRAWINGS.
 7. CONTRACTOR IS TO CHECK AND CONFIRM EXISTING CONDITIONS ON SITE, LEVELS, ALIGNMENTS, EXISTING RETAINED STRUCTURE AND ALL OTHER NECESSARY INFORMATION, PRIOR TO COMMENCING ANY WORKS. NOTIFY THE SUPERINTENDENT OF ANY OMISSIONS OR DISCREPANCIES AND SEEK WRITTEN ADVICE PRIOR TO PROCEEDING.

- SCOPE NOTES:**
1. CLEAN, PREPARE AND PAINT ALL SURFACES WITHIN THE SCOPE OF WORKS AREA, INCLUDING BUT NOT LIMITED TO CONCRETE FACADE ELEMENTS, EXPOSED STRUCTURE AND SERVICES, RAINWATER GOODS AND CLADDING. PROVIDE DETAILED SHOP DRAWINGS INCLUDING BUT NOT LIMITED TO: WINDOWS, DOORS, JOINERY, PARTITION SYSTEMS, CLADDING SYSTEM AND FRAMING SYSTEMS.
 2. INSTALL NEW HIGH PERFORMANCE ALUMINIUM WINDOWS TO EXTENT INDICATED ON DRAWINGS.
 3. INSTALL WINDOW SILLS AND ALUMINIUM TRIMS TO PERIMETER OF SPANDRELS CAVITY.
 4. INSTALL NEW MECHANICAL LOUVERS AS SHOWN.
 5. INSTALL NEW ROOF AND FACADE ACCESS SYSTEM, REFER ROOF PLAN.
 6. INSTALL NON-COMBUSTIBLE ALUMINIUM CLADDING TO THE CENTRAL LIFT TO GROUND FLOOR.

- WORKS NOTES:**
1. SETOUT IS TO BE IN ACCORDANCE WITH ARCHITECTURAL DRAWINGS.
 2. ALL DESIGN AND INSTALLATION OF ROOFING TO COMPLY WITH AS1562.1.
 3. ALL ROOF PLUMBING TO COMPLY WITH AS/NZS 3500.3.2.
 4. ALL RAIN WATER GOODS MATERIAL TO COMPLY WITH AS/NZS 2179.1.
 5. ALL FLASHING AND CAPPING TO COMPLY WITH AS/NZS 2904.
 6. REFER SERVICES ENGINEERS DOCUMENTATION FOR PROPOSED WORKS TO AND CONNECTION TO EXISTING SERVICES. BEFORE COMMENCING WORKS INSPECT THE SITE AND OBTAIN MEASUREMENTS AND OTHER NECESSARY INFORMATION AS REQUIRED.
 7. ALL NEW SERVICES RETICULATION TO BE CONCEALED.

- EXTERNAL FINISHES LEGEND:**
- X-BW** EXISTING BRICKWORK
 - M-P23a** EXTERIOR PAINT FINISH - FACADE COLUMNS
 - M-P23b** EXTERIOR PAINT FINISH - FACADE SPANDRELS
 - X-RN1** EXISTING RENDER - PAINT FINISH
 - X-RN2** EXISTING RENDER - PAINT FINISH
 - X-GL** EXISTING GLAZING
 - GL-9** HIGH PERFORMANCE EXTERNAL GLAZING - NORTH FACADE
 - GL-10** HIGH PERFORMANCE EXTERNAL GLAZING - OTHER FACADES
 - EL-01** NEW ALUMINIUM CLADDING - KNUCKLE
 - EL-02** NEW REINFORCED PRESSED CEMENT PANEL - NORTH FACADE
 - X-EL4** EXISTING CLADDING TO MOSAIC TILES
 - X-EL5** EXISTING CORRUGATED WALL CLADDING
 - X-EL6** EXISTING ALUMINIUM WALL CLADDING
 - X-CON1** EXISTING PRECAST PANEL
 - X-EL7** EXISTING FIBRE GLASS FASCIA LINING
 - X-EL8** EXISTING RIPPLE IRON SOFFIT LINING
 - X-AM1** EXISTING METAL CAPPING
 - X-SN1** ORIGINAL STONE CLADDING
 - X-AM2** EXISTING ALUMINIUM LOUVRE
 - X-AM3** EXISTING METAL SCREEN
 - X-RS1** EXISTING ROOF SHEETING - TYPE 1
 - X-RS2** EXISTING ROOF SHEETING - TYPE 2
 - X-RS3** EXISTING ROOF SHEETING - TYPE 3
 - X-EL1** EXISTING METAL WALL CLADDING
 - M-P24a** EXTERIOR PAINT FINISH - EXISTING METAL WALL CLADDING
 - X-CON2** EXTERIOR PAINT FINISH - EXISTING BLOCKWORK WALL
 - X-CL1** ORIGINAL TIMBER SLAT CEILING
 - X-SK1** ORIGINAL TERRAZZO SKIRTING
 - M-SK5** NEW TERRAZZO SKIRTING TO MATCH EXISTING
 - EL-03** NEW PERFORATED STEEL SCREEN
 - EL-04** NEW POWDER COATED STEEL COLUMNS
 - N-AM2** NEW ALUMINIUM LOUVRE

- EXTERNAL LEGEND:**
- X-BN** EXISTING BENCHES
 - X-GR** EXISTING GUARDRAILS
 - X-ME** EXISTING MECHANICAL EQUIPMENT
 - N-ME** NEW MECHANICAL EQUIPMENT. REFER TO MECH. ENGR'S DOCUMENTATION

ACOUSTIC ENGINEERING
Cundall
 L2/330 Little Collins Street
 Melbourne, VIC 3000
 T (03) 9635 3700
 cundall.com

BUILDING SURVEYOR
Steve Watson & Partners
 Level 6/ 350 Queen Street
 Melbourne, VIC 3000
 T (03) 9380 5558
 swpartners.com.au

BUILDING SERVICES ENGINEER + ESD
WSP
 Level 15/28 Freshwater Place
 Southbank, VIC 3006
 T (03) 9661 1111
 wsp.com

CIVIL, FACADE & STRUCTURE ENGINEERING
WSP
 Level 15/28 Freshwater Place
 Southbank, VIC 3006
 T (03) 9661 1111
 wsp.com

DDA CONSULTANT
Architecture & Access
 Level 5/ 369 Royal Parade
 Parkville, VIC 3052
 T 1300 715 866
 architectureandaccess.com.au

REV.	DETAILS	DATE
3	TOWN PLANNING	25/11/2021
2	TOWN PLANNING	22/09/2021
1	SCHEMATIC DESIGN	30/08/2021



PROJECT
MONASH MENZIES REDEVELOPMENT - STAGE 2
 MONASH UNIVERSITY CLAYTON CAMPUS

DRAWING TITLE
PART SOUTH ELEVATION EAST

NORTH

FOR APPROVAL
 TOWN PLANNING


SCALE
 1:100@A1

JOB No.	DRAWN	CHECKED	DATE
MM08	VK	MT	SEPT 2021

DRAWING No. CL_11_A_6024

REVISION
3

ALL DIMENSIONS ARE IN MILLIMETERS. DO NOT SCALE DRAWINGS FOR CRITICAL DIMENSIONS. CHECK DRAWING IS TO SCALE BY MEASURING SCALE BAR BELOW. VERIFY ALL DIMENSIONS ON SITE BEFORE COMMENCING ANY WORK, SHOP DRAWINGS OR ORDERING MATERIALS.

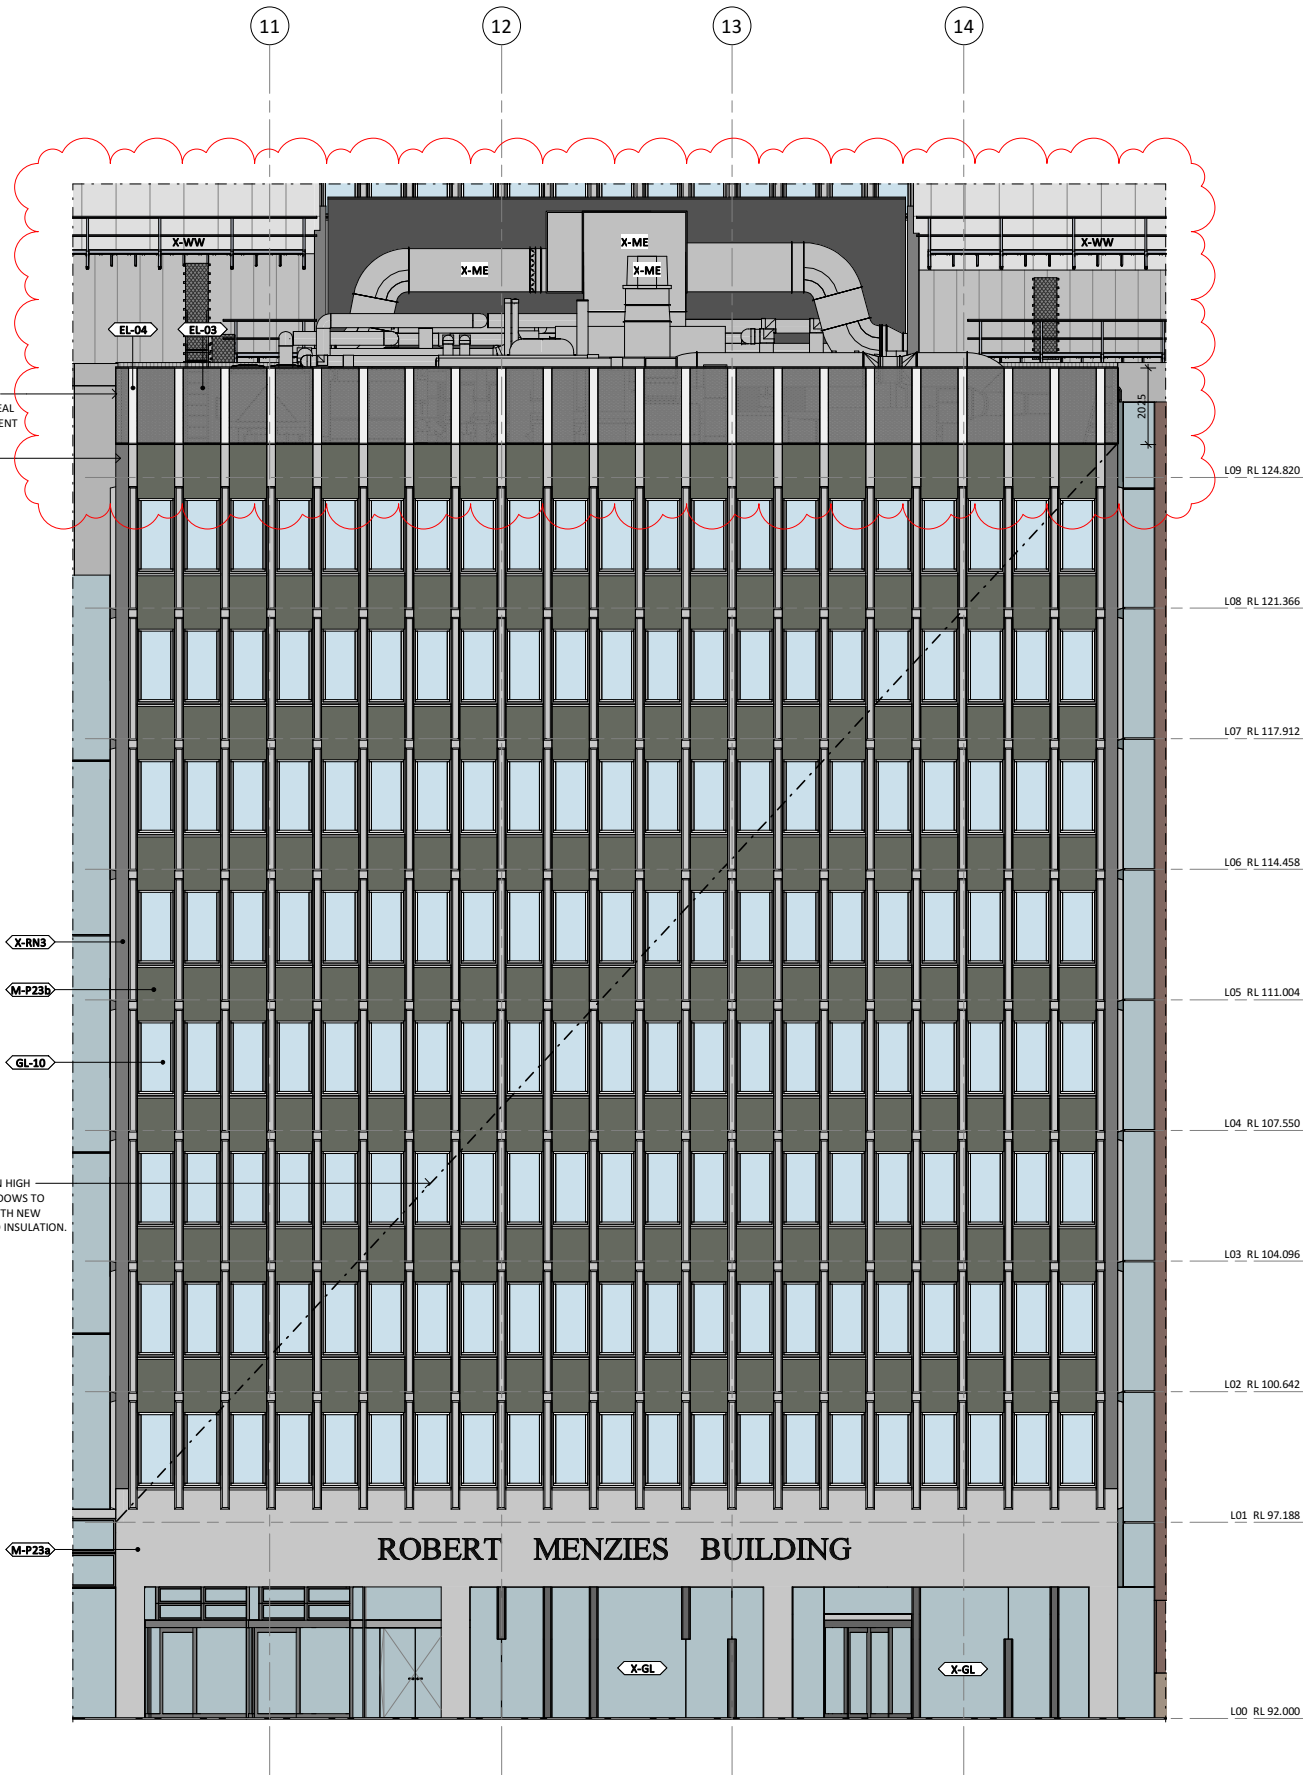

INSTALL NEW PERFORATED STEEL SCREEN AND COLUMNS TO CONCEAL THE SOUTH WING PLANT EQUIPMENT

INSTALL ROOF ACCESS SYSTEM ONTO SLAB BEHIND PARAPET

INSTALL NEW THERMALLY BROKEN HIGH PERFORMANCE ALUMINIUM WINDOWS TO EXISTING WINDOW OPENINGS, WITH NEW FLASHINGS, TAPES/SEALANTS AND INSULATION.

- GENERAL NOTES:**
1. ALL DRAWINGS ARE TO BE READ IN CONJUNCTION WITH THE ARCHITECTURAL SPECIFICATIONS.
 2. ALL DRAWINGS ARE TO BE READ IN CONJUNCTION WITH ALL CONSULTANT DOCUMENTATION.
 3. DRAWINGS OF A LARGER SCALE TAKE PRECEDENCE OVER DRAWINGS AT A SMALLER SCALE.
 4. ALL EXISTING STRUCTURAL MEMBERS AND FACADE CONSTRUCTION ARE INDICATIVE ONLY. CONTRACTOR IS TO CONFIRM ON SITE EXISTING CONDITION, LEVELS, SIZES AND FIRE RATING TREATMENT.
 5. DO NOT SCALE OFF DRAWINGS, USE DIMENSIONS ONLY.
 6. ALL DIMENSIONS ARE NOMINAL ONLY. CONTRACTOR TO CONFIRM ALL BUILT AND PROPOSED DIMENSIONS ON SITE PRIOR TO MANUFACTURE OR PREPARING SHOP DRAWINGS.
 7. CONTRACTOR IS TO CHECK AND CONFIRM EXISTING CONDITIONS ON SITE, LEVELS, ALIGNMENTS, EXISTING RETAINED STRUCTURE AND ALL OTHER NECESSARY INFORMATION, PRIOR TO COMMENCING ANY WORKS. NOTIFY THE SUPERINTENDENT OF ANY OMISSIONS OR DISCREPANCIES AND SEEK WRITTEN ADVICE PRIOR TO PROCEEDING.

- SCOPE NOTES:**
1. CLEAN, PREPARE AND PAINT ALL SURFACES WITHIN THE SCOPE OF WORKS AREA, INCLUDING BUT NOT LIMITED TO CONCRETE FACADE ELEMENTS, EXPOSED STRUCTURE AND SERVICES, RAINWATER GOODS AND CLADDING. PROVIDE DETAILED SHOP DRAWINGS INCLUDING BUT NOT LIMITED TO: WINDOWS, DOORS, JOINERY, PARTITION SYSTEMS, CLADDING SYSTEM AND FRAMING SYSTEMS
 2. INSTALL NEW HIGH PERFORMANCE ALUMINIUM WINDOWS TO EXTENT INDICATED ON DRAWINGS.
 3. INSTALL WINDOW SILLS AND ALUMINIUM TRIMS TO PERIMETER OF SPANDRELS CAVITY.
 4. INSTALL NEW MECHANICAL LOUVERS AS SHOWN.
 5. INSTALL NEW ROOF AND FACADE ACCESS SYSTEM, REFER ROOF PLAN.
 6. INSTALL NON-COMBUSTIBLE ALUMINIUM CLADDING TO THE CENTRAL LIFT TO GROUND FLOOR.

- WORKS NOTES:**
1. SETOUT IS TO BE IN ACCORDANCE WITH ARCHITECTURAL DRAWINGS
 2. ALL DESIGN AND INSTALLATION OF ROOFING TO COMPLY WITH AS1562.1.
 3. ALL ROOF PLUMBING TO COMPLY WITH AS/NZS 3500.3.2.
 4. ALL RAIN WATER GOODS MATERIAL TO COMPLY WITH AS/NZS 2179.1.
 5. ALL FLASHING AND CAPPING TO COMPLY WITH AS/NZS 2904.
 6. REFER SERVICES ENGINEERS DOCUMENTATION FOR PROPOSED WORKS TO AND CONNECTION TO EXISTING SERVICES. BEFORE COMMENCING WORKS INSPECT THE SITE AND OBTAIN MEASUREMENTS AND OTHER NECESSARY INFORMATION AS REQUIRED
 7. ALL NEW SERVICES RETICULATION TO BE CONCEALED

- EXTERNAL FINISHES LEGEND:**
- (X-BW) EXISTING BRICKWORK
 - (M-P23a) EXTERIOR PAINT FINISH - FACADE COLUMNS
 - (M-P23b) EXTERIOR PAINT FINISH - FACADE SPANDRELS
 - (X-RN1) EXISTING RENDER - PAINT FINISH
 - (X-RN2) EXISTING RENDER - PAINT FINISH
 - (X-GL) EXISTING GLAZING
 - (GL-9) HIGH PERFORMANCE EXTERNAL GLAZING - NORTH FACADE
 - (GL-10) HIGH PERFORMANCE EXTERNAL GLAZING - OTHER FACADES
 - (EL-01) NEW ALUMINIUM CLADDING - KNUCKLE
 - (EL-02) NEW REINFORCED PRESSED CEMENT PANEL - NORTH FACADE
 - (X-EL4) EXISTING CLADDING TO MOSAIC TILES
 - (X-EL5) EXISTING CORRUGATED WALL CLADDING
 - (X-EL6) EXISTING ALUMINIUM WALL CLADDING
 - (X-CON1) EXISTING PRECAST PANEL
 - (X-EL7) EXISTING FIBRE GLASS FASCIA LINING
 - (X-EL8) EXISTING RIPPLE IRON SOFFIT LINING
 - (X-AM1) EXISTING METAL CAPPING
 - (X-SN1) ORIGINAL STONE CLADDING
 - (X-AM2) EXISTING ALUMINIUM LOUVRE
 - (X-AM3) EXISTING METAL SCREEN
 - (X-RS1) EXISTING ROOF SHEETING - TYPE 1
 - (X-RS2) EXISTING ROOF SHEETING - TYPE 2
 - (X-RS3) EXISTING ROOF SHEETING - TYPE 3
 - (X-EL1) EXISTING METAL WALL CLADDING
 - (M-P24a) EXTERIOR PAINT FINISH - EXISTING METAL WALL CLADDING
 - (X-CON2) EXTERIOR PAINT FINISH - EXISTING BLOCKWORK WALL
 - (X-CL1) ORIGINAL TIMBER SLAT CEILING
 - (X-SK1) ORIGINAL TERRAZZO SKIRTING
 - (M-SK5) NEW TERRAZZO SKIRTING TO MATCH EXISTING
 - (EL-03) NEW PERFORATED STEEL SCREEN
 - (EL-04) NEW POWDER COATED STEEL COLUMNS
 - (N-AM2) NEW ALUMINIUM LOUVRE

- EXTERNAL LEGEND:**
- X-BN EXISTING BENCHES
 - X-GR EXISTING GUARDRAILS
 - X-ME EXISTING MECHANICAL EQUIPMENT
 - N-ME NEW MECHANICAL EQUIPMENT. REFER TO MECH. ENGR'S DOCUMENTATION

ACOUSTIC ENGINEERING
Cundall
 L2/330 Little Collins Street
 Melbourne, VIC 3000
 T (03) 9635 3700
 cundall.com

BUILDING SURVEYOR
Steve Watson & Partners
 Level 6/ 350 Queen Street
 Melbourne, VIC 3000
 T (03) 9380 5558
 swpartners.com.au

BUILDING SERVICES ENGINEER + ESD
WSP
 Level 15/28 Freshwater Place
 Southbank, Vic 3006
 T (03) 9861 1111
 wsp.com

CIVIL, FACADE & STRUCTURE ENGINEERING
WSP
 Level 15/28 Freshwater Place
 Southbank, Vic 3006
 T (03) 9861 1111
 wsp.com

DDA CONSULTANT
Architecture & Access
 Level 5 / 369 Royal Parade
 Parkville, VIC 3052
 T 1300 715 866
 architectureandaccess.com.au

REV.	DETAILS	DATE
3	TOWN PLANNING	25/11/2021
2	TOWN PLANNING	22/09/2021
1	SCHEMATIC DESIGN	30/08/2021



PROJECT
MONASH MENZIES REDEVELOPMENT - STAGE 2
 MONASH UNIVERSITY CLAYTON CAMPUS

DRAWING TITLE
PART SOUTH ELEVATION SOUTH

NORTH

FOR APPROVAL
 TOWN PLANNING

SCALE
 1:100@A1


JOB No.	DRAWN	CHECKED	DATE
MM08	VK	MT	SEPT 2021

DRAWING No.	REVISION
CL_11_A_6025	3


ALL DIMENSIONS ARE IN MILLIMETERS. DO NOT SCALE DRAWINGS FOR CRITICAL DIMENSIONS. CHECK DRAWING IS TO SCALE BY MEASURING SCALE BAR BELOW. VERIFY ALL DIMENSIONS ON SITE BEFORE COMMENCING ANY WORK, SHOP DRAWINGS OR ORDERING MATERIALS.



WINDOW TYPE A - EXISTING CONDITION PHOTO

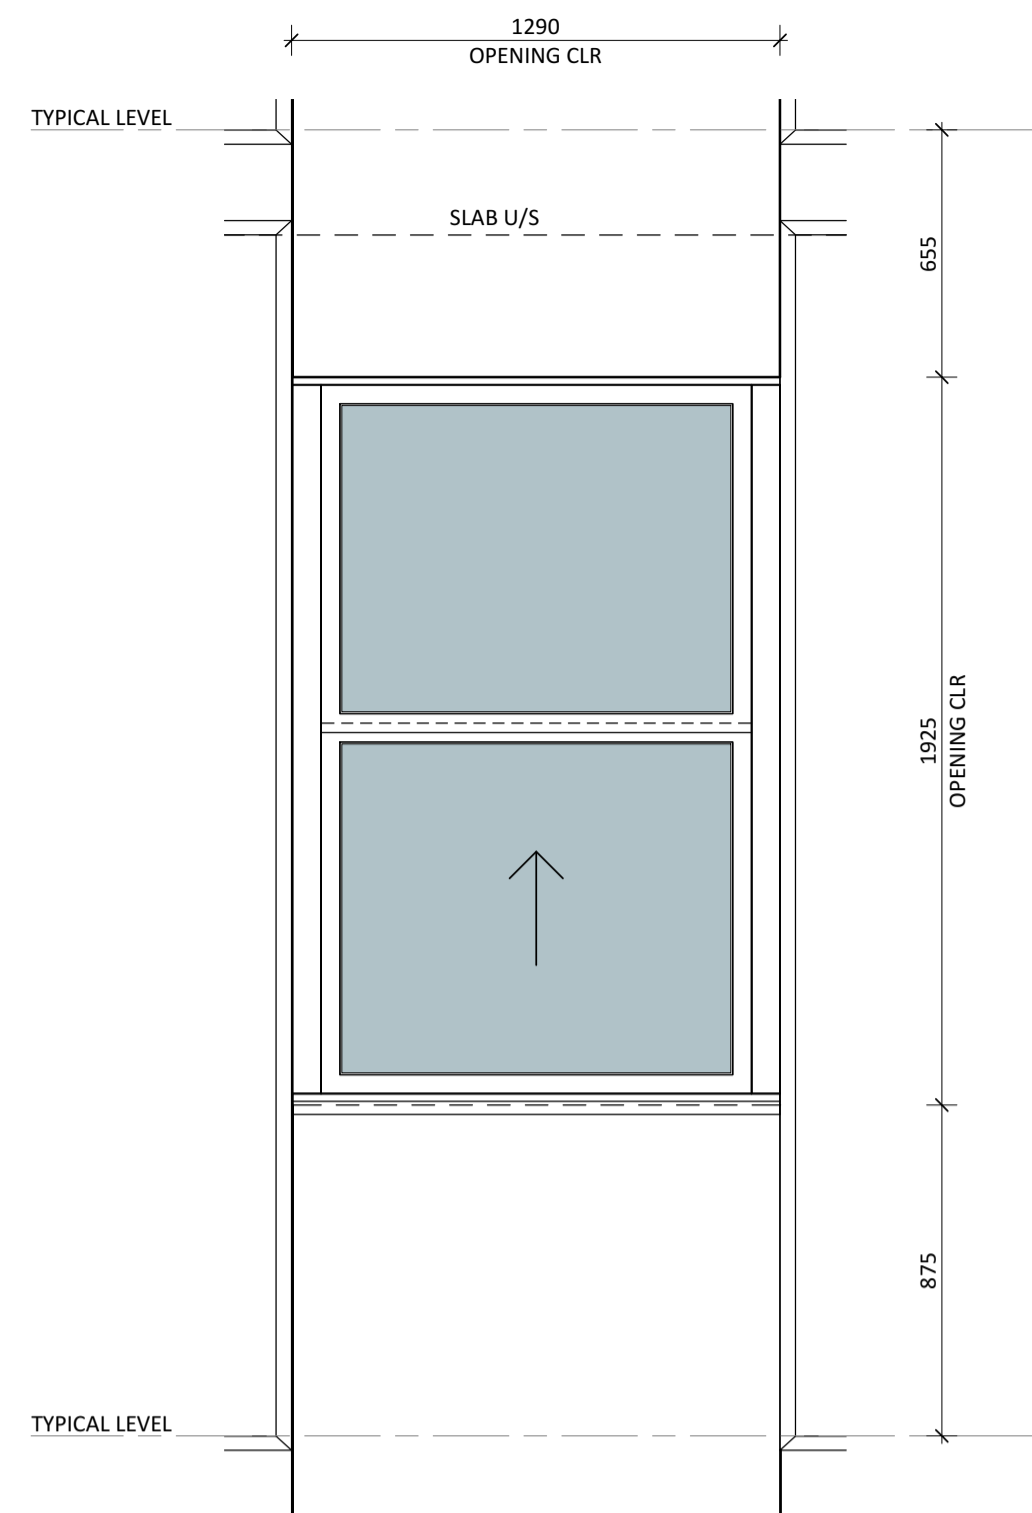


01 WINDOW TYPE A EXISTING
SCALE 1 : 20

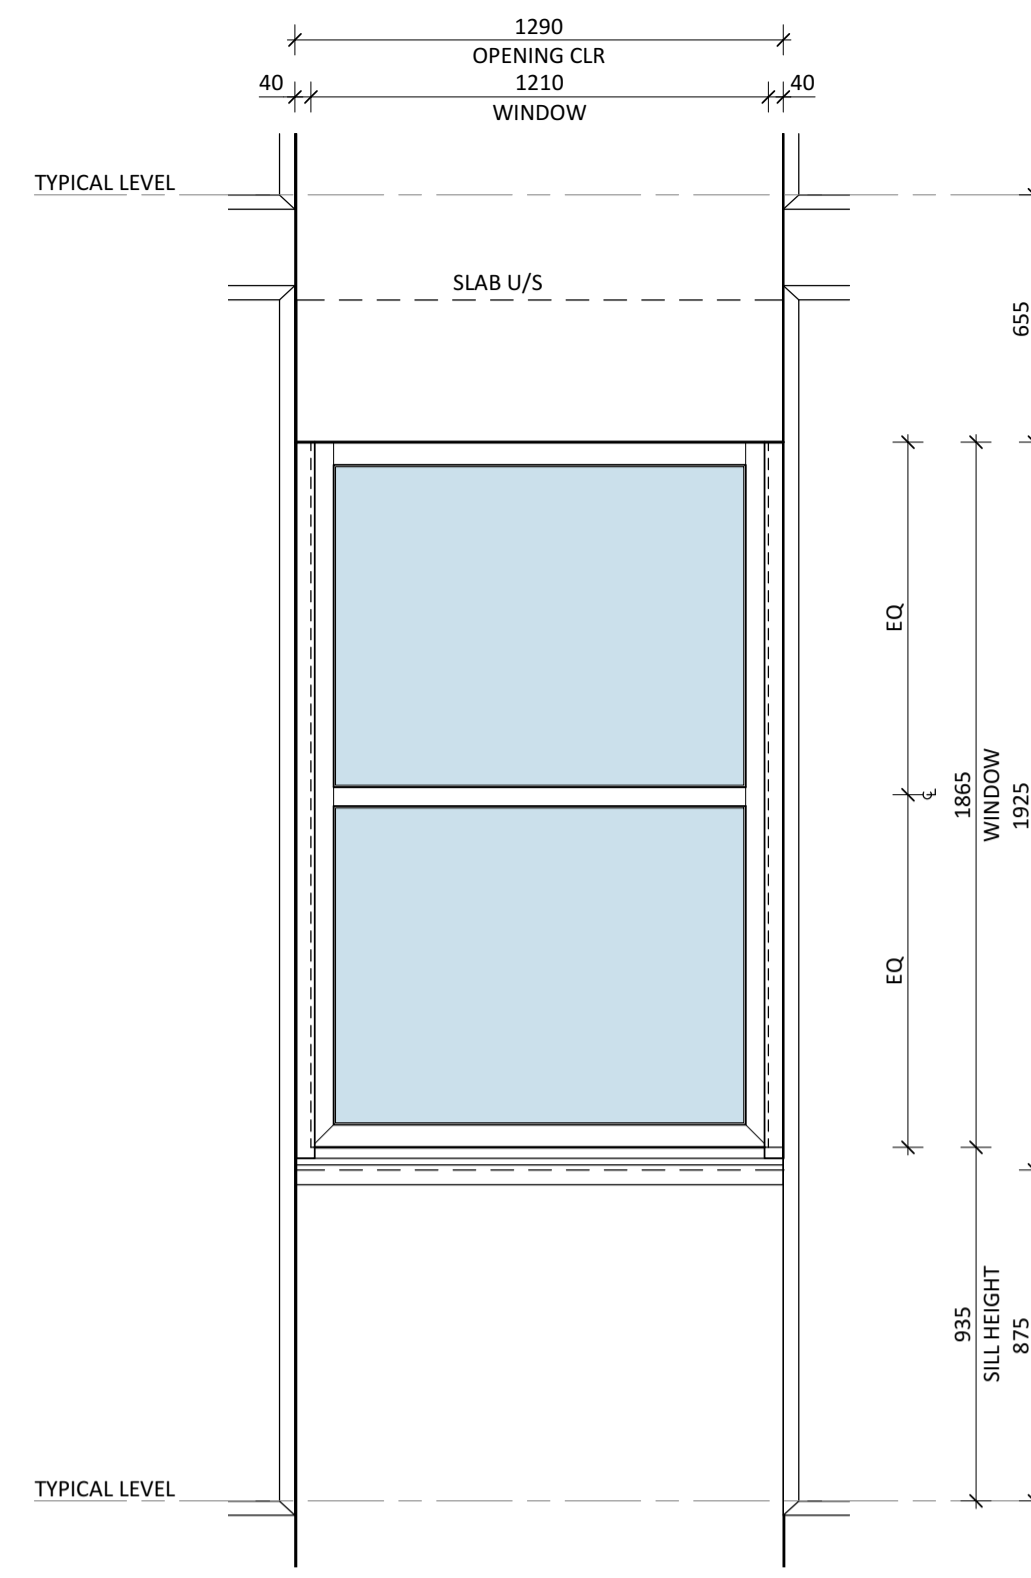


02 WINDOW TYPE A PROPOSED
SCALE 1 : 20



WINDOW TYPE H - EXISTING CONDITION PHOTO

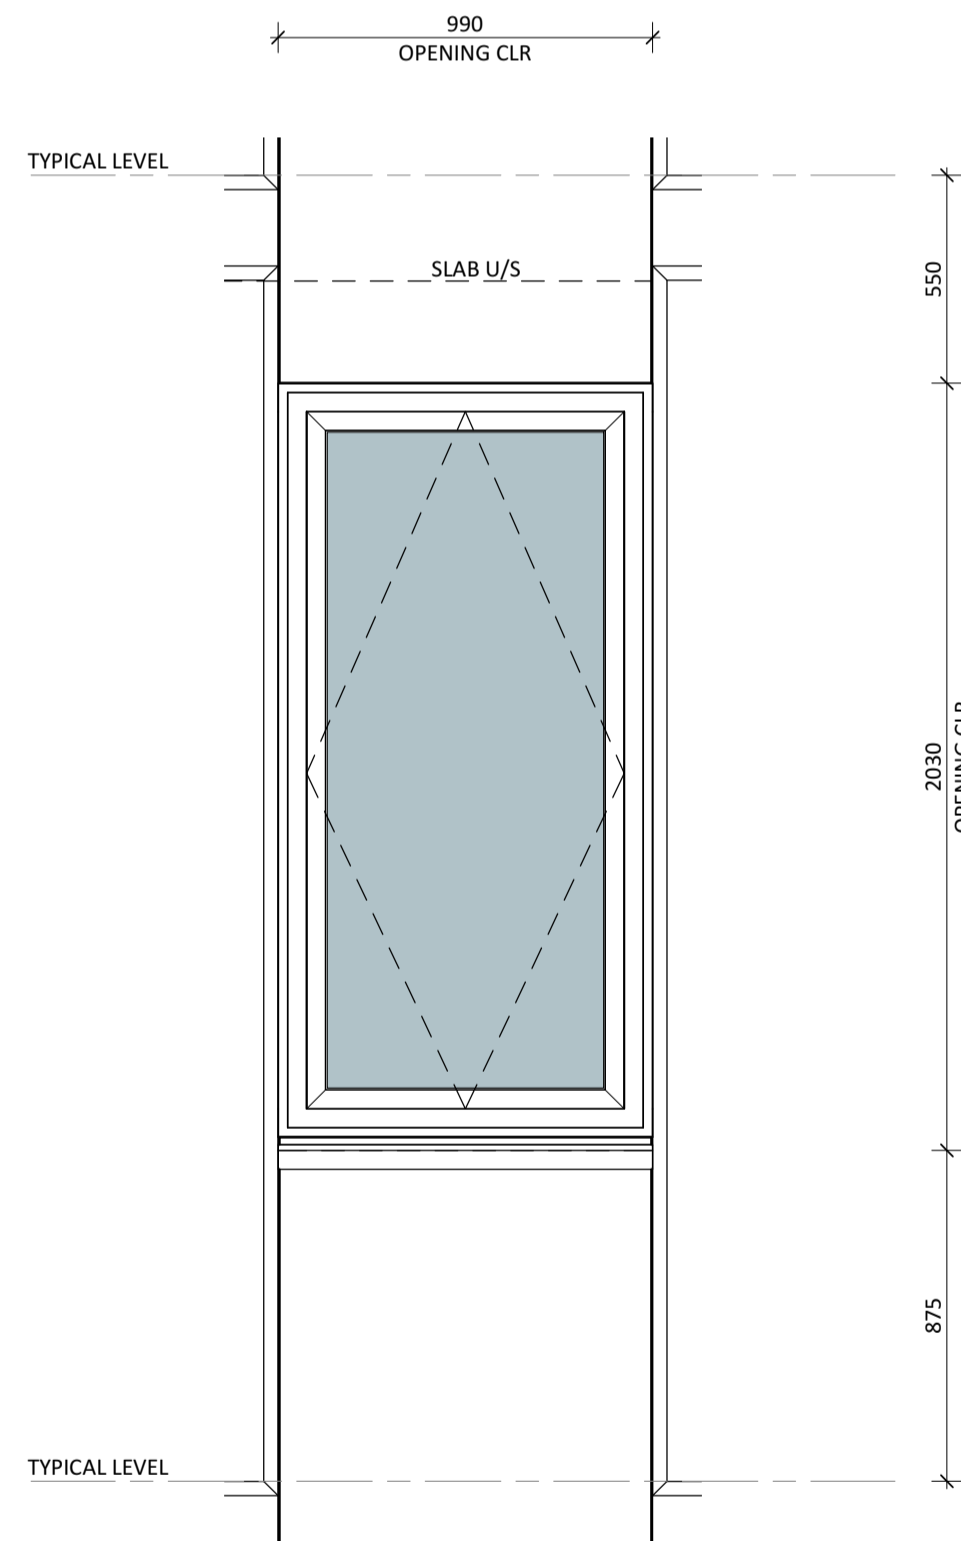

03 WINDOW TYPE H EXISTING
SCALE 1 : 20

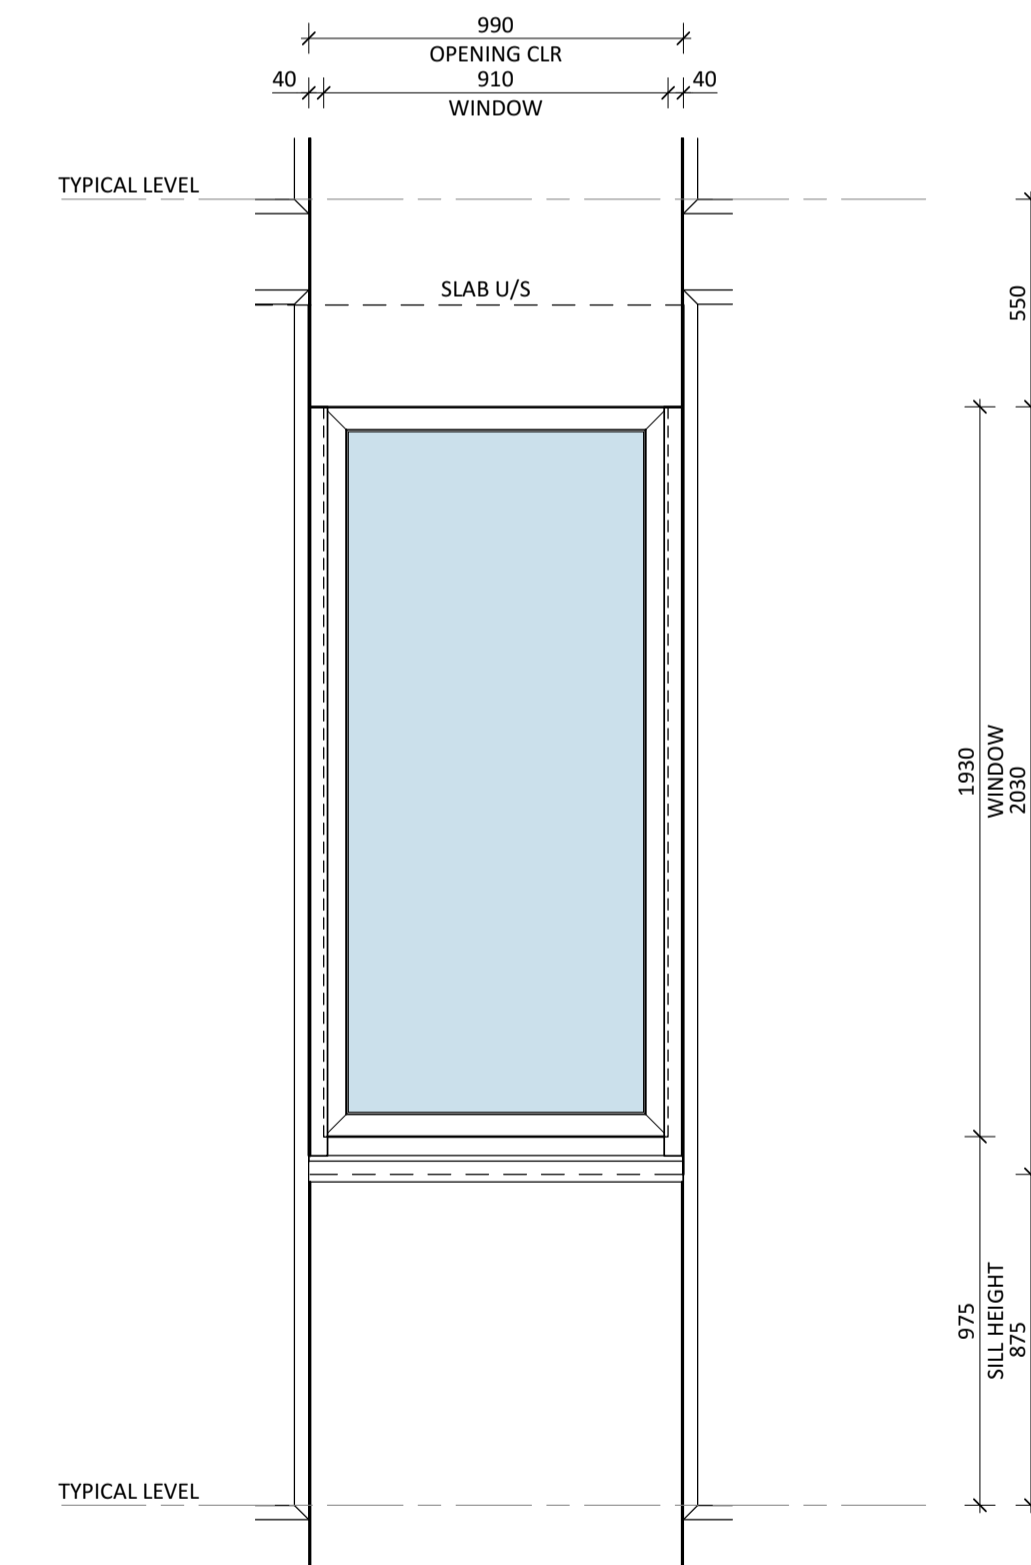

04 WINDOW TYPE H PROPOSED
SCALE 1 : 20

FILE: BIM_360/MM08_Monash Menzies AE_LC_9104_Menzies Building_Rev42021.rvt
PRINTED: 22/09/2021 15:52:07 PM
A1 594 x 841

ACOUSTIC ENGINEERING
Cundall
L2/330 Little Collins Street
Melbourne, VIC 3000
T (03) 9635 3700
cundall.com

BUILDING SURVEYOR
Steve Watson & Partners
Level 6 / 350 Queen Street
Melbourne, VIC 3000
T (03) 9380 5558
swpartners.com.au

BUILDING SERVICES ENGINEER + ESD
WSP
Level 15/28 Freshwater Place
Southbank, Vic 3006
T (03) 9861 1111
wsp.com

CIVIL, FACADE & STRUCTURE ENGINEERING
WSP
Level 15/28 Freshwater Place
Southbank, Vic 3006
T (03) 9861 1111
wsp.com

DDA CONSULTANT
Architecture & Access
Level 5 / 369 Royal Parade
Parkville, VIC 3052
T 1300 715 866
architectureandaccess.com.au

REV. DETAILS DATE
1 TOWN PLANNING 22/09/21



PROJECT
MONASH MENZIES
REDEVELOPMENT - STAGE 2
MONASH UNIVERSITY CLAYTON CAMPUS

DRAWING TITLE
TYPICAL WINDOW
ELEVATIONS - EXISTING
AND PROPOSED

NORTH

FOR APPROVAL
DESIGN DEVELOPMENT

SCALE
1:20@A1

JOB No. DRAWN CHECKED DATE
MM08 VK MT SEPT 2021

DRAWING No. REVISION
CL_11_A_6040 1

ALL DIMENSIONS ARE IN MILLIMETERS. DO NOT SCALE DRAWINGS FOR CRITICAL DIMENSIONS.
CHECK DRAWING IS TO SCALE BY MEASURING SCALE BAR BELOW. VERIFY ALL DIMENSIONS
ON SITE BEFORE COMMENCING ANY WORK, SHOP DRAWINGS OR ORDERING MATERIALS.



MONASH MENZIES BUILDING REFURBISHMENT

DATE : SEPT 2021
 CLIENT : MONASH UNIVERSITY
 REVISION : 1

EXTERNAL FINISHES

1. COLUMNS- DULUX SNOW SEASON QUARTER SN4E1
2. NEW WINDOWS- BRUSHED ALUMINIUM
3. NEW PERFORATED STEEL SCREEN
4. HIGH PERFORMANCE CLEAR GLAZING

5. REINFORCED PRESSED CEMENT PANEL
6. SPANDREL PANELS- DULUX ENDLESS DUSK SN4G3
7. EAST & WEST WALLS- DULUX ATOM BLUE P38B3
8. EXISTING ALUMINIUM WINDOWS
9. EXPOSED BRICK

LOVELL CHEN

LEVEL 5, 176 WELLINGTON PARADE
 EAST MELBOURNE 3002
 AUSTRALIA
 TEL +61 (0)3 9667 0800
 www.lovellchen.com.au

Monash Heritage Study

1-131 Wellington Road, Clayton North

Monash University, Robert Menzies School of Humanities,

H084

21-2

Also see [21-1](#)

Sheet 1 of 2



Photo: March 1998

Existing Designations:

Heritage Council Register: Nil

National Estate Register: Nil

National Trust Register: Nil

Description: The Robert Menzies School of Humanities appears as the largest building on the Monash University campus and is of reinforced concrete construction with pre-cast concrete cladding. T shaped on plan, the first stage consisted of the eastern end of the main north facing wing. It was extended to the west to form what is now the main wing and at a later date a north south wing was provided on the south face. The main wing is twelve storeys in height with a deep recess to the roofline giving definition to the building form. Façade treatment is in green and white pre-cast concrete using shapes that are characteristic of the time. There is a colonnade at the base of the main wing and the end elevations, facing east and west, are metal clad, presumably to make allowance for further expansion should that have been required.

Inside there are escalators conveying people from the ground floor level to level 9. The interior public spaces appear to be substantially intact and representative of office building practices of the day. The lift core is faced with exfoliated green slate. A drop ceiling at the lift doors has a decorative battened treatment, repeated over the colonnade entrance, the floors are finished in patterned vinyl tiles and the floors in some areas are in green terrazzo. The main staircase has open treads with wrought iron balustrade and a varnished timber handrail.

Condition: Sound

Integrity: High

Monash Heritage Study

1-131 Wellington Road, Clayton North

Monash University, Robert Menzies School of Humanities,

H084

21-2

Sheet 2 of 2

History: The 287 acre site for the new Monash University had been obtained by late in 1958 and by January the following year, Bates Smart and McCutcheon had been appointed architects to prepare a master plan for the site. It was completed by July, 1959 and the first students admitted in 1960. The School of Humanities was designed by architects Eggleston, MacDonald and Secomb, engineering design being undertaken by W.L.Irwin and Associates. The contractor for stage one, completed in 1963, was E.A.Watts Pty. Ltd.

References:

- Cross-Section*, 12/58, 1/59, 7/59, 12/63.
 - Hattwell, W., *Wandering around Waverley*, 1990, pp.399-401.
-

Thematic Context:

Educating

- Establishing schools
-

Statement of Significance: The Monash University School of Humanites, known colloquially as the “Ming Wing”, is historically important as the first landmark building to be erected on the Monash University campus (Criterion A). This importance is enhanced by the fact that the Monash campus was the first University to be established in Victoria outside of the Melbourne University. In this respect, the building demonstrates the growth in demand for higher level education centred on Melbourne’s south-eastern suburbs experienced late in the 1950’s. Although its construction system and appearance are representative of their period (Criterion D) the standard of accommodation was considered at the time to be of the highest standard.

Recommendations:

- Recommended for inclusion on the Schedule to the Heritage Overlay.
-


Assessment: Andrew Ward, March 1998.

Attachment 3: 1-131 Wellington Road, Clayton (Menzies Building)





Planning Overlays and Zones

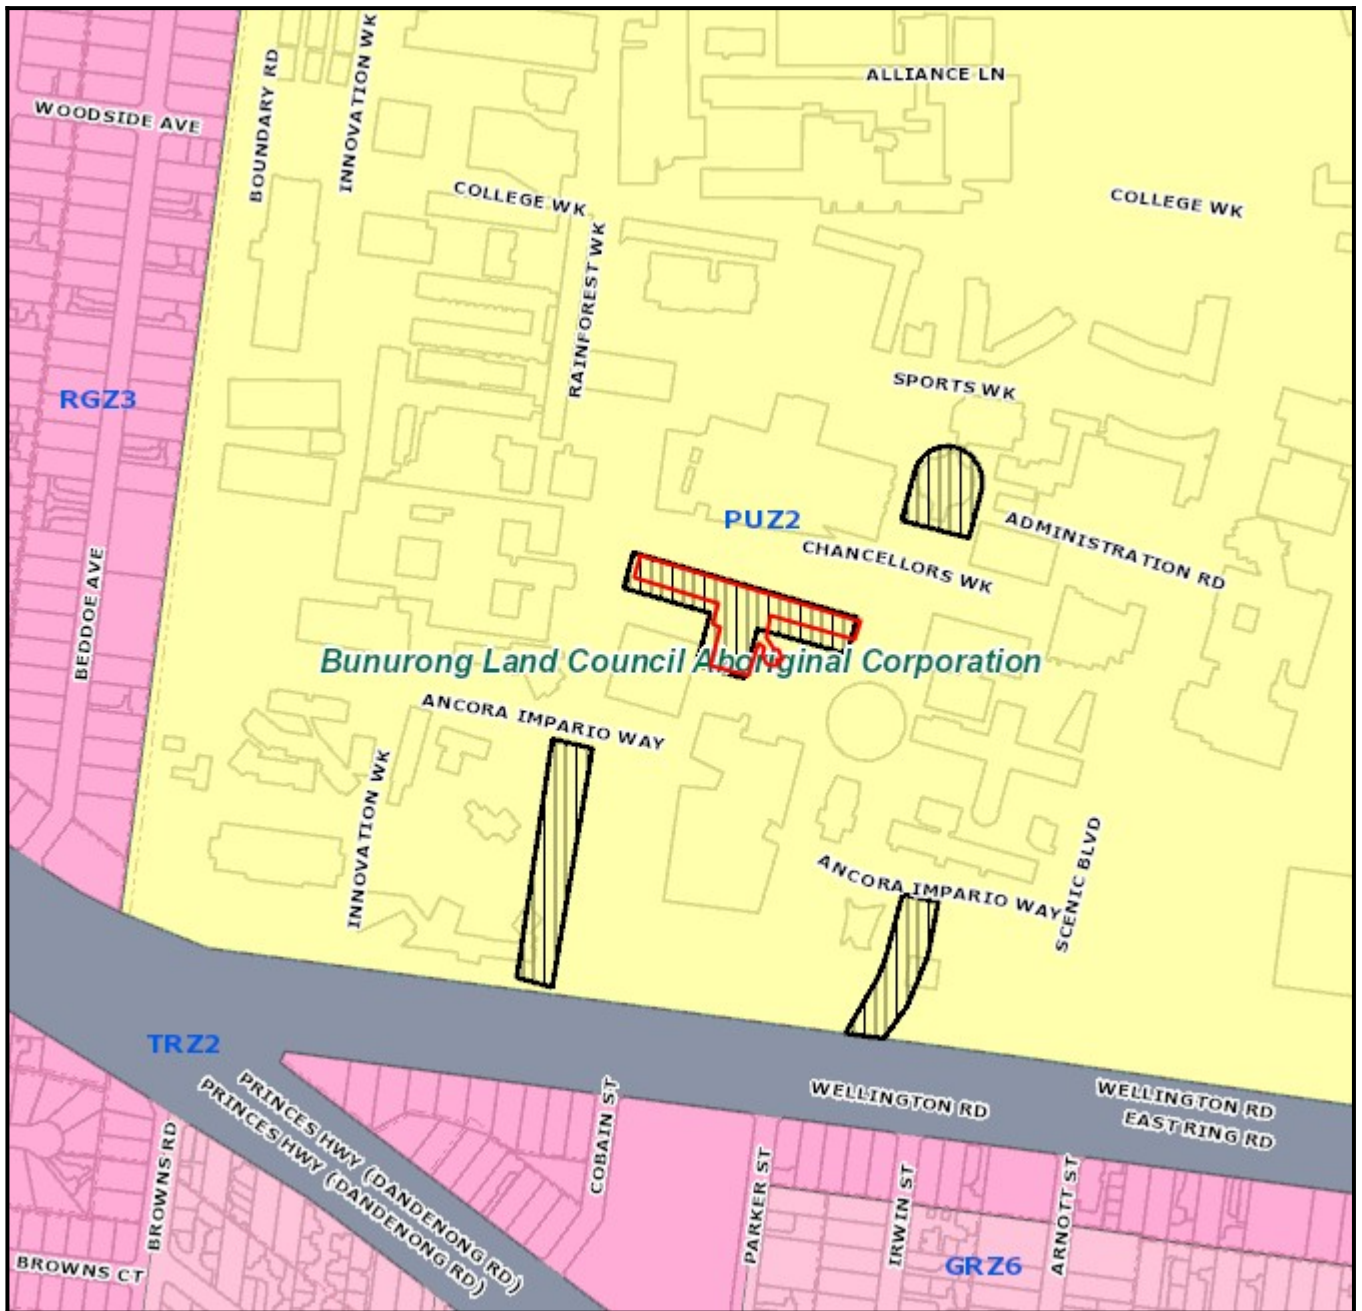

Legend

Planning Zones

C1Z	GRZ10	GRZ7	MUZ2	PCRZ	PUZ4	RGZ1	SUZ3
C2Z	GRZ2	GRZ8	NRZ1	PPRZ	PUZ5	RGZ3	SUZ4
CA	GRZ3	GRZ9	NRZ2	PUZ1	PUZ6	RGZ4	SUZ5
CDZ1	GRZ5	IN1Z	NRZ3	PUZ2	PUZ7	RGZ5	SUZ6
GRZ1	GRZ6	MUZ	NRZ4	PUZ3	RDZ1	SUZ2	UFZ

Planning Overlays

DDO	EAO	IPO	NCO	PO
DPO	HO	LSIO / SBO	FAO	VPO



1:5000

Address

1-131 Wellington Road, Clayton (Menzies Building)